1032 North Park Road Victoria, B.C. ISSUED FOR BUILDING PERMIT 10 SEPTEMBER, 2014

ARCHITECTURAL

FINLAYSON BONET ARCHITECTURE 4 - 7855 East Saanich Rd. Saanichton V8M 2B4 Phone: 250-656-2224

Architect of Record: Siliva Bonet, Architect AIBC

Contacts: Silvia Bonet / Kyle Shick


>	A0.00 A1.00 A1.01 A1.02	COVER SHEET SITE PLAN & PROJECT DATA SITE SERVICING PLAN ASSEMBLIES	
> >	A2.00 A2.01	1ST FLOOR, 2ND FLOOR SLAB PLAN & 2ND FLOOR PLAN 3RD, 4TH FLOOR & ROOF PLAN	
> >	A3.00 A3.01 A3.02	NORTH & SOUTH ELEVATIONS EAST ELEVATION WEST ELEVATION	•
>	A4.00 A4.01 A4.02	BUILDING SECTIONS BUILDING SECTIONS BUILDING SECTIONS	•
> >	A5.00 A5.00 A5.00	STAIRS & ELEVATOR PLANS STAIRS 1 & 2 AND ELEVATOR SECTIONS STAIRS - PLANS & SECTIONS	
•	A6.00 A6.01 A6.02 A6.03	SECTION DETAILS SECTION DETAILS NOT USED ROOF DETAILS	•
•	A6.05 A6.06	WALL SECTION DETAILS PLAN DETAILS WALL REVEAL DETAILS DETAILS -WINDOWS AND DOORS DETAILS -WINDOWS AND DOORS	<
•	A0.08 A6.09 A7.00 A7.01		<
	A8.00 A8.01	WINDOW SCHEDULE DOOR SCHEDULE	<

CIVIL

GARY CARROTHERS CONSULTING Suite 208 - 2750 Quadra Street Victoria, BC V8T 4E8 Phone: 250-388-6919

Contact: Gary Carrothers, P.Eng.

CIVIL

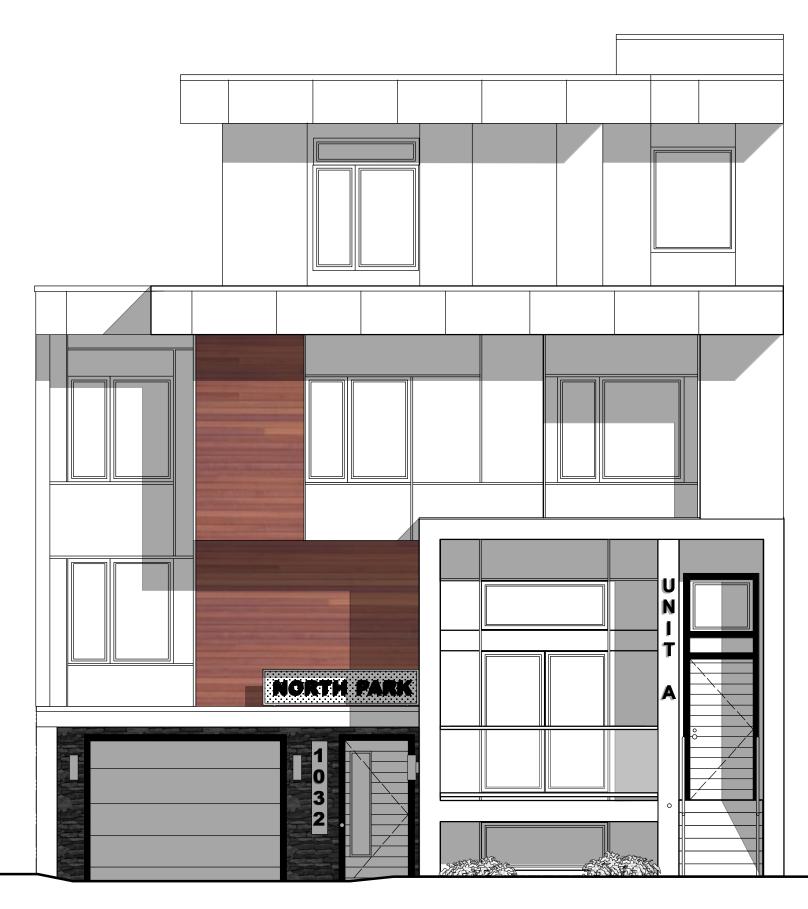

STRUCTURAL

JSH ENGINEERING 665 Blacktail Road Victoria, BC V9B 6G2 Phone: (250) 474-2662

Contact: Steve Hoel, P.Eng.

- S1 STRUCTURAL NOTES
- S2 CONCRETE DETAILS
- S3 CONCRETE DETAILS
- S4 FOUNDATION, SUSPENDED SLAB & SECOND FLOOR PLANS
- S5 3RD & 4TH FLOOR PLANS & ROOF FRAMING
- S6 FRAMING DETAILS
- S7 SECTIONS & DETAILS

MECHANICAL

AME Group 721 Johnson Street Victoria, BC V8W 1M8 Phone: (250) 382-5999 Contact: CassidyTaylor, P.Eng. M0.00 COVER SHEET M0.01 SCHEDULES M1.00 FOUNDATION PLAN M2.00 PLUMBING, 1ST, 2ND 3R FLOOR PLANS M2.01 PLUMBING 4TH FLOOR & ROOF PLAN M4.00 MECHANICAL 1ST. 2ND & 3RD FLOOR PLANS M4.01 MECHANICAL 4TH FLOOR & ROOF PLAN M5.00 MECHANICAL ROOM LAYOUT AND SECTIONS M6.00 PLUMBING SCHEMATICS M6.01 DOMESTIC WATER AND FIRE SCHEMATIC M6.02 VENTILATION SCHEMATIC M7.00 DETAILS

ELECTRICAL

TRIUMPH ELECTRICAL ENGINNEERING 1472 Cranbrook Place Victoria. BC V8P 1Z7 Phone: 250-385-3713


Contact: Steve Cooke, P.Eng.

- E1 SYMBOL SCHEDULE, MECHANICAL SCHEDULE, UNIT PANEL. TRENCH DETAILS & SITE PLAN
- E2 FIRST, SECOND, THIRD & FOURTH FLOOR PLANS & ELECTRICAL ROOM DETAIL
- E3 UNIT PLAN LAYOUTS 1-11




Door #	Location Info Door Name	Door Style	Size	Swing	Material	Finish	Label	Glazing	Hdwe	Frame Material	Finish	Wall Type	Notes
101	BEDROOM 101 TO CLOSET	1	3'-0" x 6'-8"	-	HCW	PT	-	-	PASSAGE	WD	PT	SEE PLAN	
102 103	MEDIA ROOM 102 TO BEDROOM 101 MEDIA ROOM 102 TO LAUNDRY 104	1	2'-0" x 6'-8" 2'-8" x 6'-8"	LH LH	HCW HCW	PT PT	-	-	PRIVACY PASSAGE	WD WD	PT PT	SEE PLAN SEE PLAN	
104	MEDIA ROOM 102 TO WC103	1	2'-6" x 6'-8"	LH	HCW	PT	-	-	PRIVACY	WD	PT	SEE PLAN	
<u>105</u> 106	VEST 105 TO MECH. ROOM 105 PARKADE 113 TO VEST. 105	2	3'-0" x 7'-0" 3'-0" x 7'-0"	RHR LRH	HM HM	PT PT	1.0 HR 1.0 HR	-	ENTRY ENTRY	PS PS	PT PT	SEE PLAN SEE PLAN	CL, GA, WS CL, GA, WS
107 108	VEST. 105 TO ELEC. ROOM 107 PARKADE 113 TO LOBBY 111	2	3'-0" x 7'-0" 3'-0" x 7'-0"	RH BHB	HM HM	PT PT	1.0 HR 1.0 HR	- TEMP'D	ENTRY P/PULL	PS PS	PT PT	SEE PLAN SEE PLAN	CL, GA, WS CL, GA, HS, WS
109	LOBBY 111 TO ST1 108	3	3'-0" x 7'-0"	RHR	HM	PT	1.0 HR	TEMP'D	P/PULL	PS	PT	SEE PLAN	ĆL, ĠA, ŴS
<u>110</u> 111	PARKADE 113 TO BICYCLE STORAGE 112 EXTERIOR TO PARKADE 113	1 5	3'-0" x 7'-0" 9'-0" x 7'-0"	RHR O/H	HM HM	PT PT	-	-	ENTRY	PS PS	PT PT	SEE PLAN SEE PLAN	CL, GA, WS
112	EXTERIOR TO PARKADE 113	4	3'-0" x 7'-0"	RHR	HM	PT	-	TEMP'D	PANIC	PS	PT	SEE PLAN	CL
201	EXTERIOR TO CORR 201	1	3'-0" x 7'-0"	RHR	HM	PT	45 MIN	-	ENTRY	PS	PT	SEE PLAN	CL, GA, WS
202 203	CORR 201 TO UNIT 1 UPPER KITCHEN 203 TO CLOSET	2	3'-0" x 7'-0" 3'-0" x 6'-8"	RH RH	HM HCW	PT PT	45 MIN -	-	ENTRY PASSAGE	PS WD	PT PT	SEE PLAN SEE PLAN	GA
204 205	HALL TO WC 103	1	2'-6" x 6'-8"	RH	HCW	PT PT	-	-	PRIVACY PRIVACY	WD WD	PT	SEE PLAN SEE PLAN	
206	HALL TO BEDROOM 205 BEDROOM 205 TO CLOSET	1	2'-8" x 6'-8" 3'-0" x 6'-8"	RH RH	HCW HCW	PT	-	-	PASSAGE	WD	PT PT	SEE PLAN	
207 208	LIVING ROOM 202 TO DECK CORR 201 TO ST2 209	1 3	6'-0" x 7'-0" 3'-0" x 7'-0"	RH RHR	HM HM	PT PT	45 MIN 45 MIN	-	ENTRY P/PULL	PS PS	PT PT	SEE PLAN SEE PLAN	CL, GA, WS CL, GA, WS
209	CORR 211 TO ST2 209	3	3'-0" x 7'-0"	RH	HM	PT	45 MIN	-	P/PULL	PS	PT	SEE PLAN	CL, GA, WS
210 211	CORR 211 TO ST1 208 CORR 211 TO UNIT 2	3	3'-0" x 7'-0" 3'-0" x 7'-0"	LH LH	HM HM	PT PT	45 MIN 45 MIN	-	P/PULL ENTRY	PS PS	PT PT	SEE PLAN SEE PLAN	CL, GA, WS GA
212 213	HALL TO WC 219 NOT USED	1	2'-8' x 6'-8"	LH	HCW	PT	-	-	PRIVACY	WD	PT	SEE PLAN	
214	HALL TO LAUNDRY 220	1	2'-8' x 6'-8"	LH	HCW	PT	-	-	PASSAGE	WD	PT	SEE PLAN	
215 216	BEDROOM 221 TO CLOSET HALL TO BEDROOM 221	1	3'-0" x 6'-8" 2'-8' x 6'-8"	LH LH	HCW HCW	PT PT		-	PRIVACY PASSAGE	WD WD	PT PT	SEE PLAN SEE PLAN	
217	LIVING ROOM 222 TO BEDROOM 223	1	3'-0" x 6'-8"	LH	HCW	PT	-	-	PRIVACY	WD	PT	SEE PLAN	
<u>218</u> 219	BEDROOM 223 TO CLOSET CORR 211 TO UNIT 3	1 2	3'-0" x 6'-8" 3'-0" x 7'-0"	- RH	HCW HM	PT PT	- 45 MIN	-	PASSAGE ENTRY	WD PS	PT PT	SEE PLAN SEE PLAN	GA
220 221	LIVING ROOM 216 TO WC 218 LIVING ROOM 216 TO CLOSET	1	3'-0" x 6'-8" 3'-0" x 6'-8"	LH RH	HCW HCW	PT PT	-	-	PRIVACY PASSAGE	WD WD	PT PT	SEE PLAN SEE PLAN	
222	LIVING ROOM 216 TO BEDROOM 217	1	2'-8' x 6'-8"	LH	HCW	PT	-	-	PRIVACY	WD	PT	SEE PLAN	
223 224	BEDROOM 217 TO CLOSET LIVING ROOM 216 TO BEDROOM 215	1	4'-0" x 6'-8" 2'-8' x 6'-8"	- LH	HCW HCW	PT PT	-	-	PASSAGE PRIVACY	WD WD	PT PT	SEE PLAN SEE PLAN	
225	BEDROOM 215 TO CLOSET	1	4'-0" x 6'-8"	-	HCW	PT	-	-	PASSAGE	WD	PT	SEE PLAN	
226 227	CORR 211 TO UNIT 4 LIVING ROOM 213 TO BEDROOM 214	2	3'-0" x 7'-0" 2'-8" x 6'-8"	LH RH	HM HCW	PT PT	45 MIN -	-	ENTRY PRIVACY	PS WD	PT PT	SEE PLAN SEE PLAN	GA
228 229	BEDROOM 214 TO CLOSET LIVING ROOM 213 TO LAUNDRY 212	1	4'-0" x 6'-8" 4'-0" x 6'-8"	-	HCW HCW	PT PT	-	-	PASSAGE PASSAGE	WD WD	PT PT	SEE PLAN SEE PLAN	
230	HALL TO WC 206	1	2'-6" x 6'-8"	LH	HCW	PT	-	-	PRIVACY	WD	PT	SEE PLAN	
231 232	HALL TO BEDROOM 207 BEDROOM 207 TO CLOSET	1	2'-8" x 6'-8" 3'-0" x 6'-8"	RH -	HCW HCW	PT PT		-	PRIVACY PASSAGE	WD WD	PT PT	SEE PLAN SEE PLAN	
301	CORR 303 TO ST2 309	3	3'-0" x 7'-0"	RH	HM	PT	45 MIN	-	P/PULL	PS	PT	SEE PLAN	CL, GA, WS
302	CORR 303 TO ST1 308	3	3'-0" x 7'-0"	LH	HM	PT	45 MIN	-	P/PULL	PS	PT	SEE PLAN	CL, GA, WS
<u> </u>	COR 303 TO UNIT 5 HALL TO WC 319	2	3'-0" x 7'-0" 2'-8" x 6'-8"	LH LH	HM HCW	PT PT	45 MIN -	-	ENTRY PRIVACY	PS WD	PT PT	SEE PLAN SEE PLAN	GA CL, GA, WS
305 306	HALL TO LAUNDRY 320	1	2'-8" x 6'-8"	LH	HCW HCW	PT PT	-	-	PASSAGE PRIVACY	WD WD	PT PT	SEE PLAN SEE PLAN	
307	HALL TO BEDROOM 321 BEDROOM 321 TO CLOSET	1	3'-0" x 6'-8" 2'-8" x 6'-8"	LH LH	HCW	PT	-	-	PASSAGE	WD	PT	SEE PLAN	
308 309	LIVING ROOM 322 TO BEDROOM 323 BEDROOM 323 TO CLOSET	1	2'-8" x 6'-8" 3'-0" x 6'-8"	LH 	HCW HCW	PT PT	-	-	PRIVACY PASSAGE	WD WD	PT PT	SEE PLAN SEE PLAN	
310	CORR 311 TO UNIT 6	2	3'-0" x 7'-0"	RH	HM	PT	45 MIN	-	ENTRY	PS	PT	SEE PLAN	GA
<u>311</u> 312	LIVING ROOM 316 TO WC 317 LIVING ROOM 316 TO CLOSET	1	2'-8" x 6'-8" 3'-0" x 6'-8"	LH RH	HCW HCW	PT PT	-	-	PRIVACY PASSAGE	WD WD	PT PT	SEE PLAN SEE PLAN	
313 314	LIVING ROOM 316 TO BEDROOM 318 BEDROOM 318 TO CLOSET	1	2'-8" x 6'-8" 4'-0" x 6'-8"	LH -	HCW HCW	PT PT	-	-	PRIVACY PASSAGE	WD WD	PT PT	SEE PLAN SEE PLAN	
315	LIVING ROOM 316 TO BEDROOM 315	1	2'-8" x 6'-8"	- LH	HCW	PT	-	-	PRIVACY	WD	PT	SEE PLAN	
<u>316</u> 317	BEDROOM 315 TO CLOSET CORR 311 TO UNIT 7	1 2	4'-0" x 6'-8" 3'-0" x 7'-0"	- LH	HCW HM	PT PT	- 45 MIN	-	PASSAGE ENTRY	WD PS	PT PT	SEE PLAN SEE PLAN	GA
318	LIVING ROOM 313 TO BEDROOM 314	1	2'-8" x 6'-8"	RH	HCW	PT	-	-	PRIVACY	WD	PT	SEE PLAN	Girt
<u>319</u> 320	BEDROOM 314 TO CLOSET LIVING ROOM 313 TO LAUNDRY 312	1	4'-0" x 6'-8" 4'-0" x 6'-8"	-	HCW HCW	PT PT	-	-	PASSAGE PASSAGE	WD WD	PT PT	SEE PLAN SEE PLAN	
321 322	HALL TO WC 306 HALL TO BEDROOM 307	1	2'-6" x 6'-8" 2'-8" x 6'-8"	LH RH	HCW HCW	PT PT	-	-	PRIVACY PRIVACY	WD WD	PT PT	SEE PLAN SEE PLAN	
323	BEDROOM 307 TO CLOSET	1	3'-0" x 6'-8"	-	HCW	PT	-	-	PASSAGE	WD	PT	SEE PLAN	
324 325	CORR 311 TO UNIT 8 HALL TO CLOSET	2	3'-0" x 7'-0" 1'-6" x 6'-8"	RH LHR	HM HCW	PT PT	45 MIN -	-	ENTRY PASSAGE	PS WD	PT PT	SEE PLAN SEE PLAN	GA
326	HALL TO WC 302	1	2'-6" x 6'-8"	LH	HCW	PT	-	-	PRIVACY	WD	PT	SEE PLAN	
327 328	HALL TO LAUNDRY 303 HALL TO BEDROOM 305	1	2'-0" x 6'-8" 2'-8" x 6'-8"	RHR RH	HCW HCW	PT PT	-	-	PASSAGE PRIVACY	WD WD	PT PT	SEE PLAN SEE PLAN	
329 330	BEDROOM 305 TO CLOSET HALL TO BEDROOM 304	1	3'-0" x 6'-8" 2'-8" x 6'-8"	- LH	HCW HCW	PT PT	-	-	PASSAGE PRIVACY	WD WD	PT PT	SEE PLAN SEE PLAN	
331	BEDROOM 304 TO CLOSET	1	4'-0" x 6'-8"	-	HCW	PT	-	-	PASSAGE	WD	PT	SEE PLAN	
332	HALL TO CLOSET	1	2'-0" x 6'-8"	RHR	HCW	PT	-	-	PASSAGE	WD	PT	SEE PLAN	
401	CORR 411 TO ST2 409	3	3'-0" x 7'-0"	RH	HM	PT PT	45 MIN	-	ENTRY	PS	PT PT	SEE PLAN SEE PLAN	CL, GA, WS
402 403	CORR 411 TO ST1 408 CORR 411 TO UNIT 9	3	3'-0" x 7'-0" 3'-0" x 7'-0"	LH LH	HM HM	PT PT	45 MIN 45 MIN	-	ENTRY ENTRY	PS PS	PT PT	SEE PLAN	CL, GA, WS GA
404 405	HALL TO CLOSET HALL TO WC 407	1	3'-0" x 6'-8" 2'-6" x 6'-8"	LH LH	HCW HCW	PT PT	-	-	PASSAGE PRIVACY	WD WD	PT PT	SEE PLAN SEE PLAN	
406	LIVING ROOM 412 TO CLOSET	1	1'-6" X 6'-8"	LHR	HCW	PT	-	-	PASSAGE	WD	PT	SEE PLAN	
407 408	LIVING ROOM 412 TO BEDROOM 413 BEDROOM 413 TO CLOSET	1	2'-8" x 6'-8" 6'-0" X 6'-8"	LH -	HCW HCW	PT PT		-	PRIVACY PASSAGE	WD WD	PT PT	SEE PLAN SEE PLAN	
409 410	CORR 411 TO UNIT 10 HALL TO BEDROOM 406	2	3'-0" x 7'-0"	RH	HM HCW	PT PT	45 MIN	-	ENTRY PRIVACY	PS	PT	SEE PLAN SEE PLAN	GA
411	BEDROOM 406 TO CLOSET	1	2'-8" x 6'-8" 6'-0" X 6'-8"	RH -	HCW	PT	-	-	PASSAGE	WD WD	PT PT	SEE PLAN	
412 413	HALL TO WC 405 CORR 411 TO UNIT 11	1 2	2'-6" x 6'-8" 3'-0" x 7'-0"	RH RH	HCW HM	PT PT	- 45 MIN	-	PRIVACY ENTRY	WD PS	PT PT	SEE PLAN SEE PLAN	GA
414	HALL TO WC	1	2'-6" x 6'-8"	RH	HCW	PT	-	-	PRIVACY	WD	PT	SEE PLAN	
415	HALL TO BEDROOM 401 BEDROOM 401 TO CLOSET	1	2'-8" x 6'-8" 3'-0" x 6'-8"	LH RH	HCW HCW	PT PT	-	-	PRIVACY PASSAGE	WD WD	PT PT	SEE PLAN SEE PLAN	
416	DEDITIONIN IN TO DECOL								PASSAGE	WD	PT	SEE PLAN	

DOOR STYLES

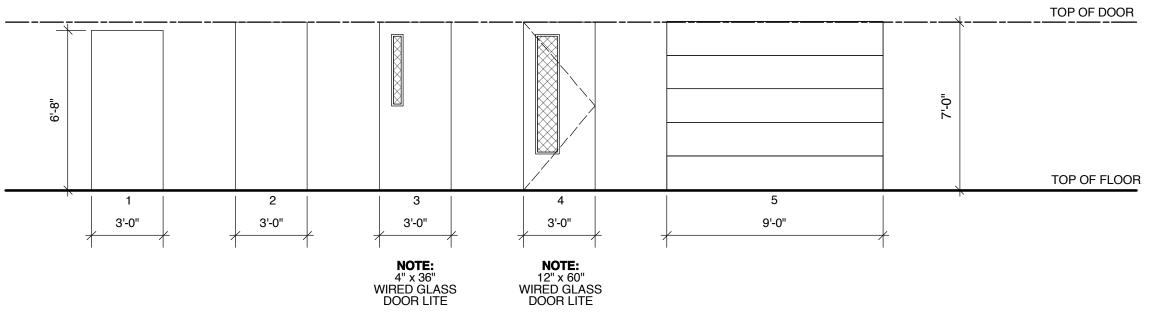



FLOAT Standard Float Glass WIRED Georgian Wired Glass TEMP'D Tempered Glass

ABBRE	VIATIONS USED IN DOC	<u>)r sche</u>	DULE
RH LH RHR LHR RHRA	Right Hand Swing Left Hand Swing Right Hand Reverse Swing Left hand Reverse Swing Right Hand Reverse Active Leaf	PANIC	Keyed Lockset Push - Pull Hardware Keyed Lockset with interior button Lockset with interior button Pushbar exit device Lockset w/o any lock
HM	Hollow Metal	CL	Door Closer
SCW	Solid Core Wood	WS	Wall Stop
HCW	Hollow Core Wood	FS	Floor Stop
AL	Aluminum	ELEC	Electric Strike
PS	Pressed Steel	PR	Proximity Reader
GL	Glazing	GA	Weatherstripping Gaskets
FACTORY	Factory Finish	KP	Kickplate
PAINT	Factory Primed - Site Painted	THROWS	Flush Bolts top and bottom
CLEAR	Clear Lacquer	HC	Handicap Actuator
ANOD	Clear Anodized	MC	Mortise Cylinder

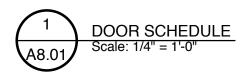



FINLAYSON BONET ARCHITECTURE LTD. #4 - 7855 East Saanich Rd. Saanichton V8M 2B4 Phone: 250-656-2224 Fax. 250-656-2279 email: info@finlaysonbonet.ca 1 02 Dec 14 B.P. Revision 08 Sep 14 Issued for B.P. Rev Date Description SMB Checked SMB/RJC Drawn Scale N.T.S. Date SEPT 10, 2014 Project Name **NORTH PARK DEVELOPMENT** 1032 NORTH PARK STREET, VICTORIA, BC Drawing Title DOOR SCHEDULE Drawing No. **A8.01** Project No. 12854 © Copyright reserved. These plans and designs are and at all times remain the property of Finlayson Bonet Architecture to be used for the project shown and may not be reproduced without written consent.

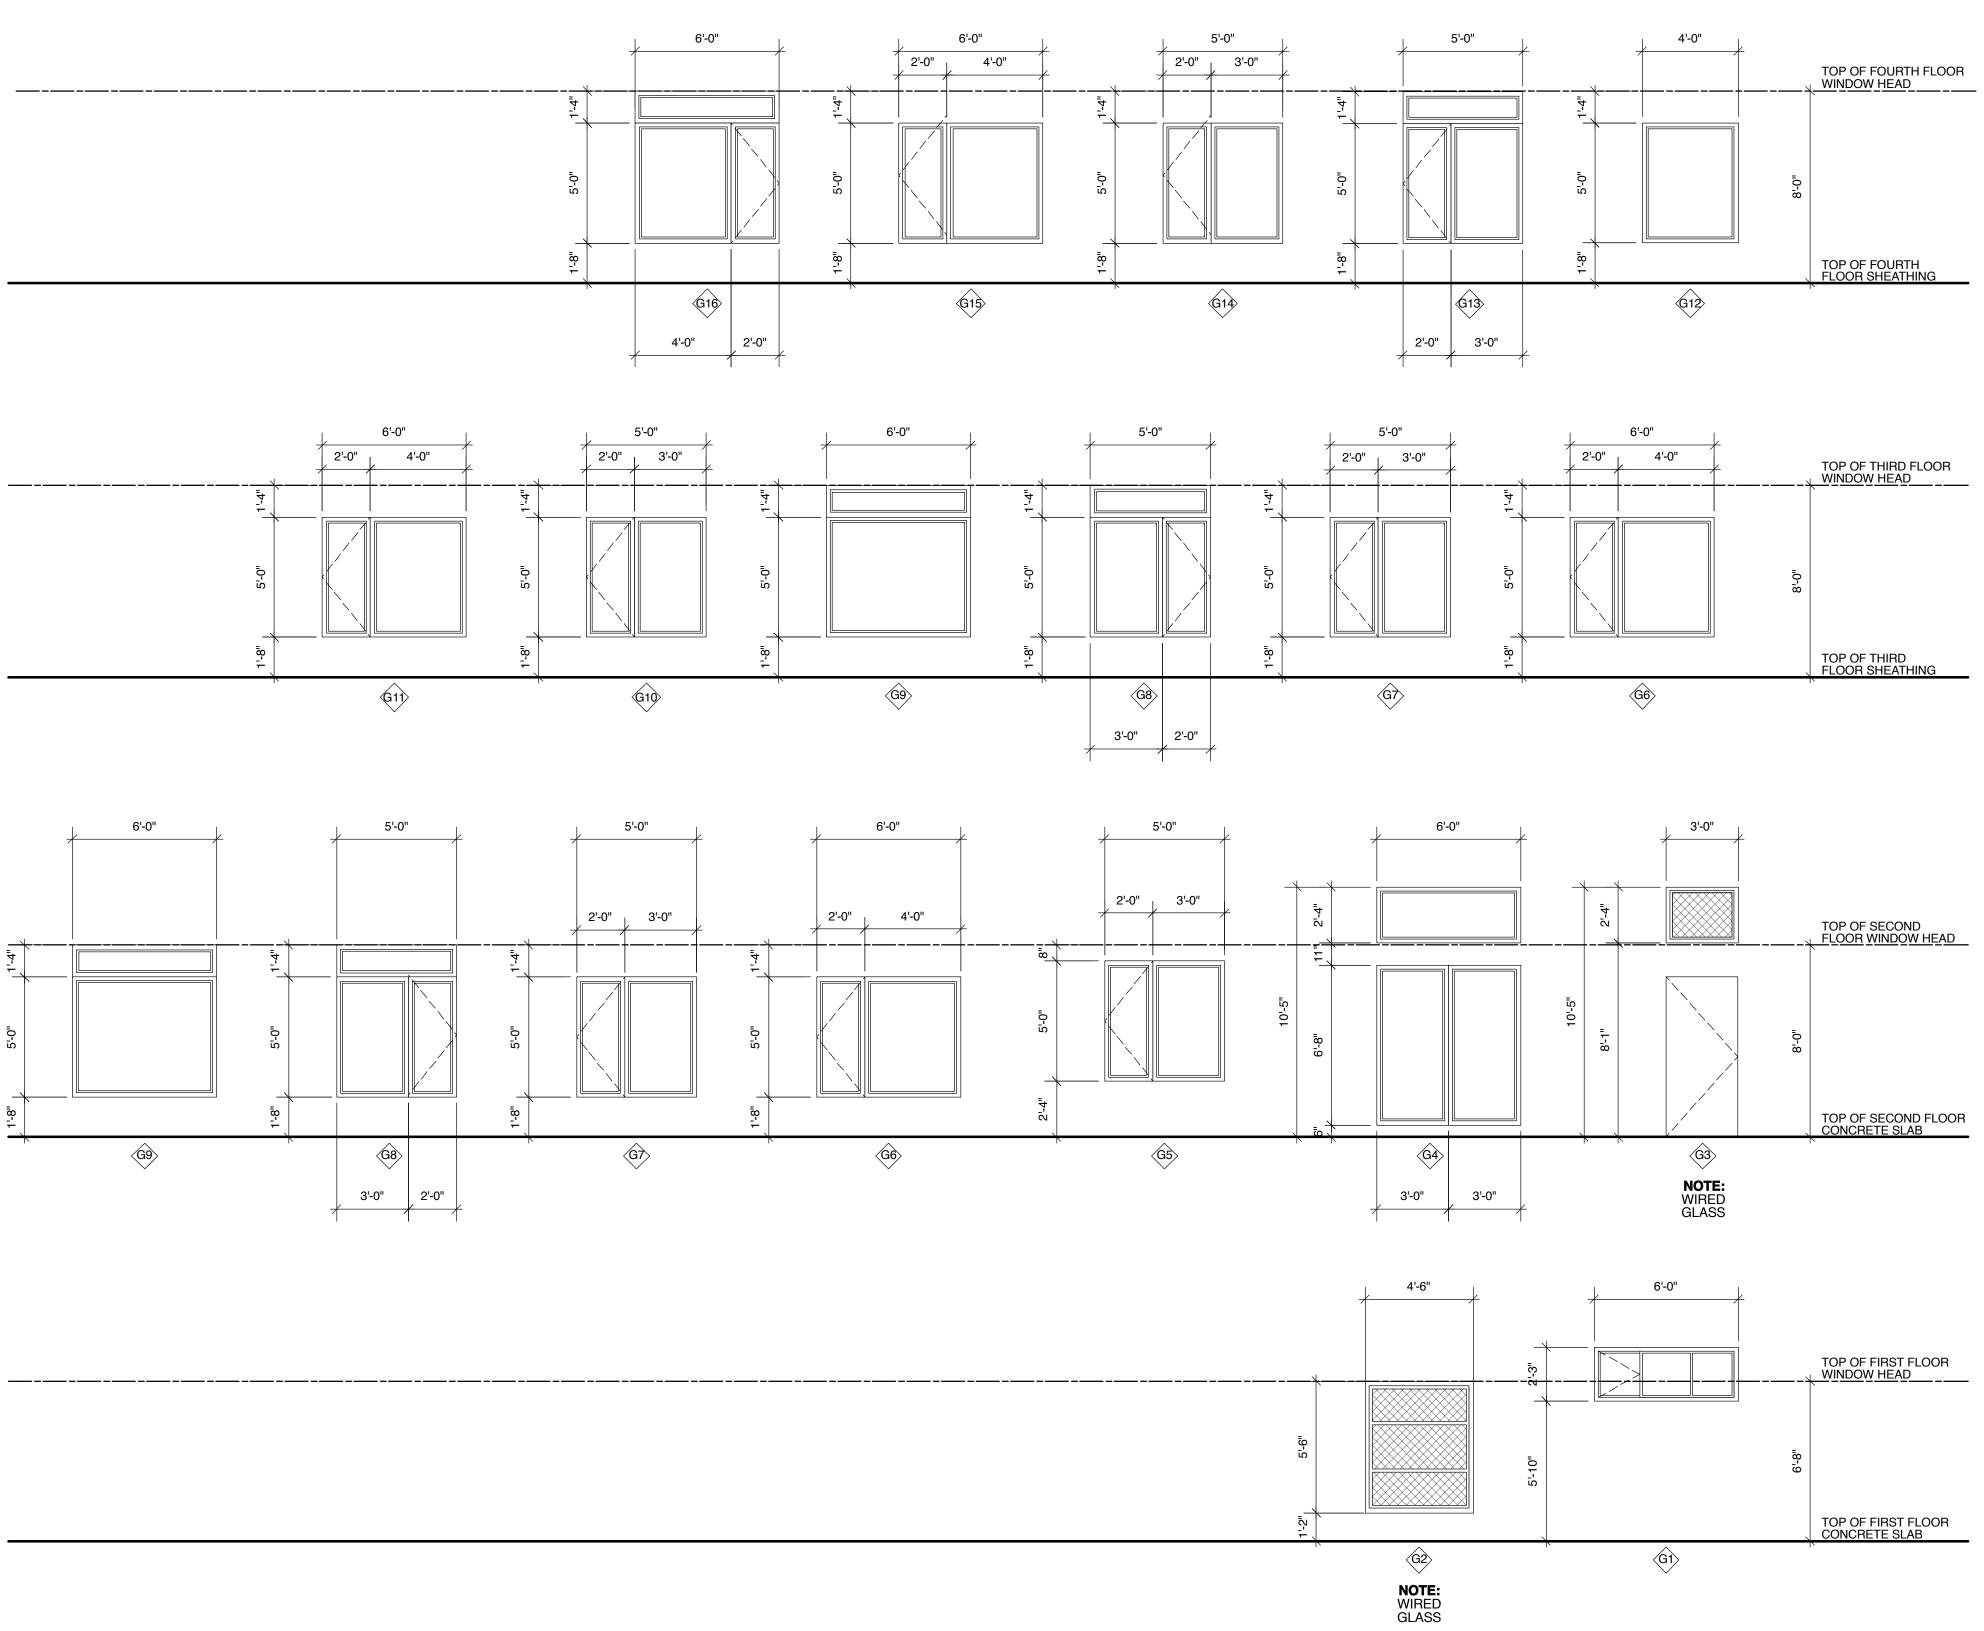

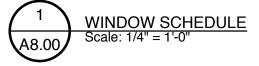



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1 02 Dec 14 B.P. Revision
08 Sep 14 Issued for B.P.
Rev Date Description
Checked SMB
Drawn SMB/RJC
Scale N.T.S.
Date SEPT 10, 2014
Project Name NORTH PARK DEVELOPMENT 1032 NORTH PARK STREET, VICTORIA, BC Drawing Title
WINDOW SCHEDULE
Drawing No. A8.00
Project No. 12854

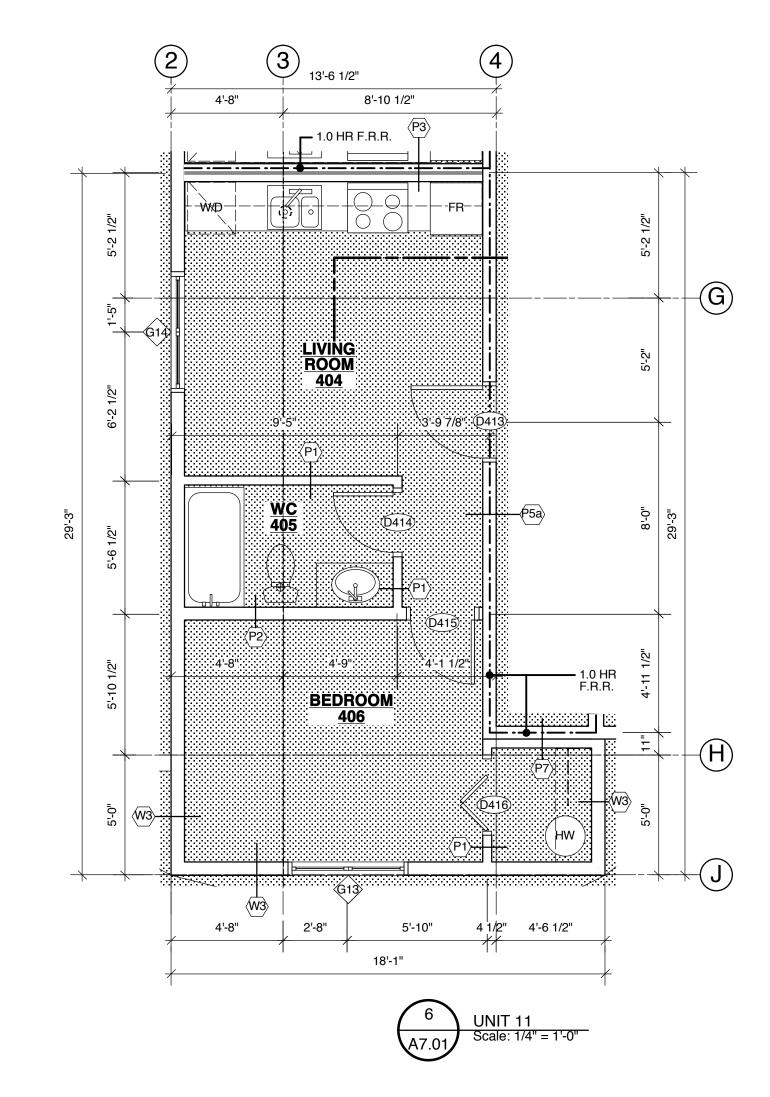


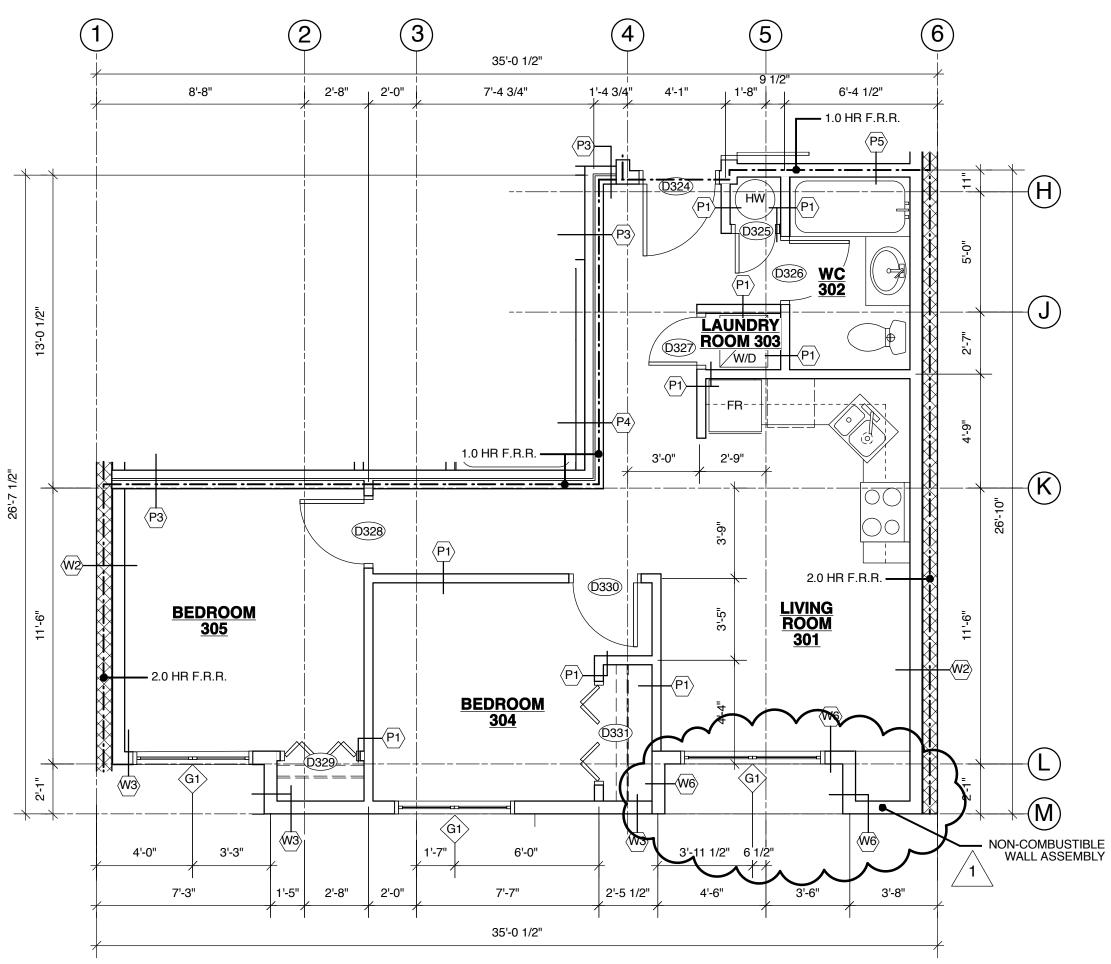


3 UNIT 8 A7.01 Scale: 1/4" = 1'-0"

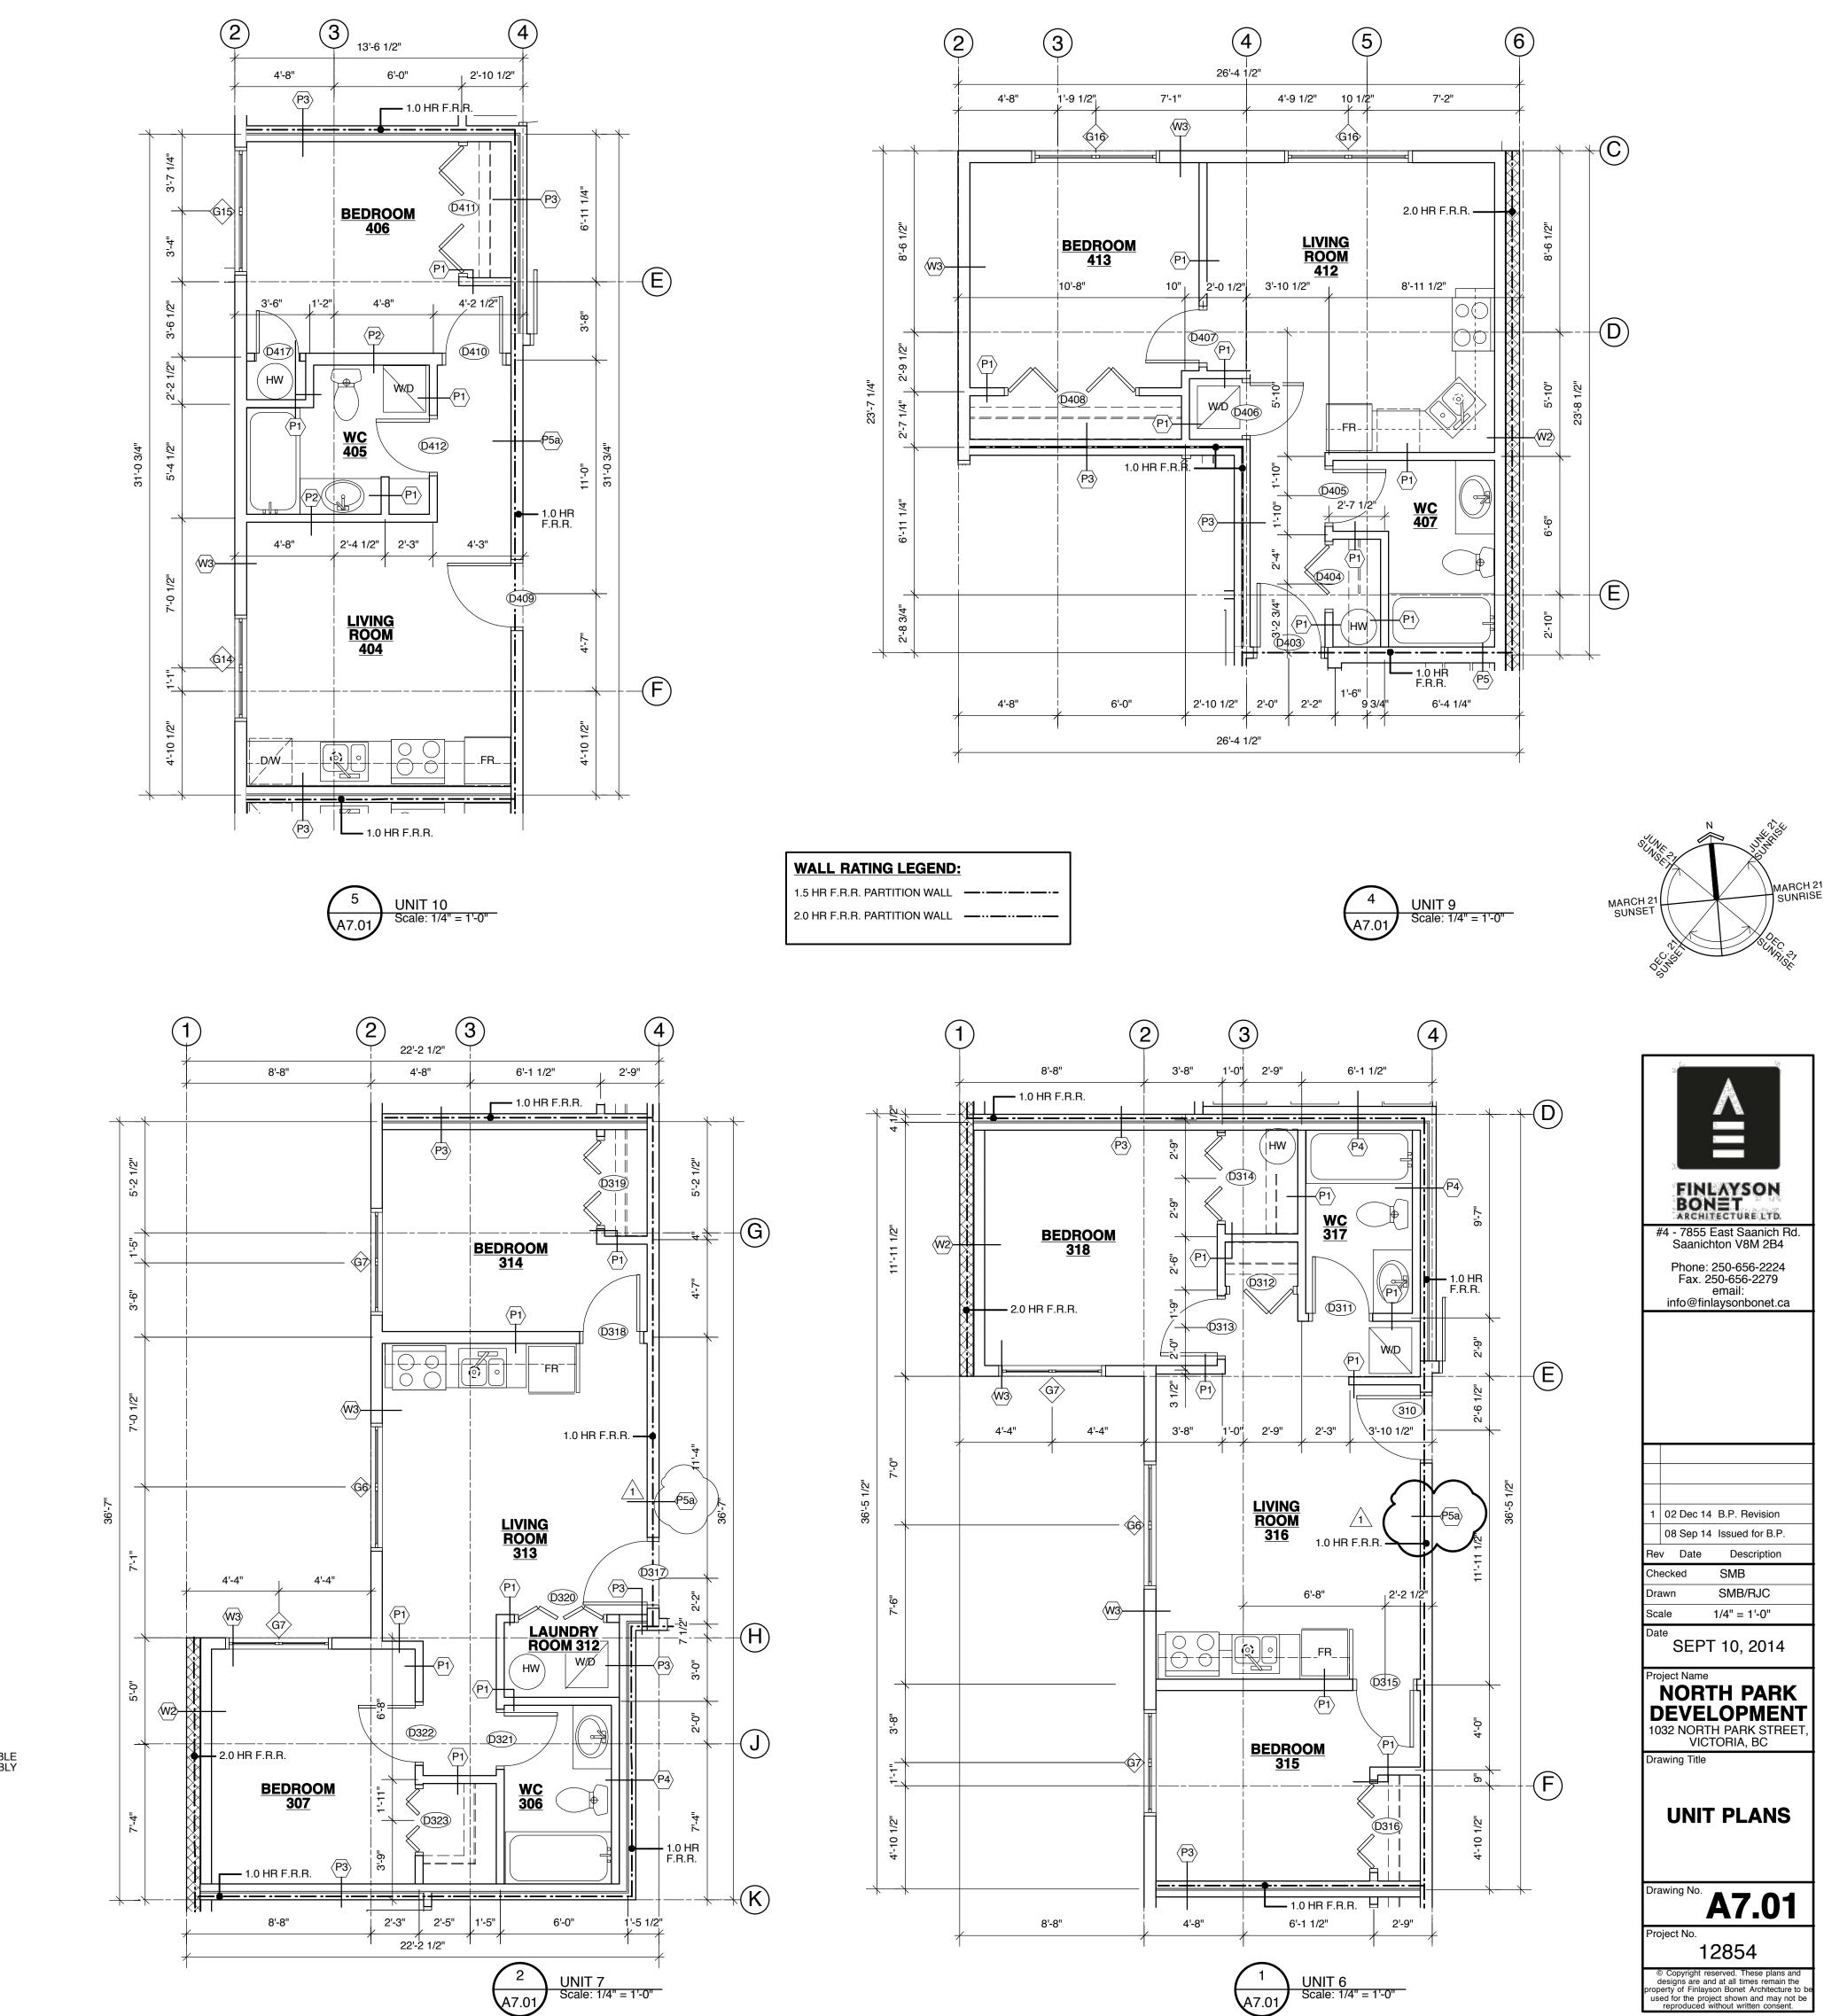

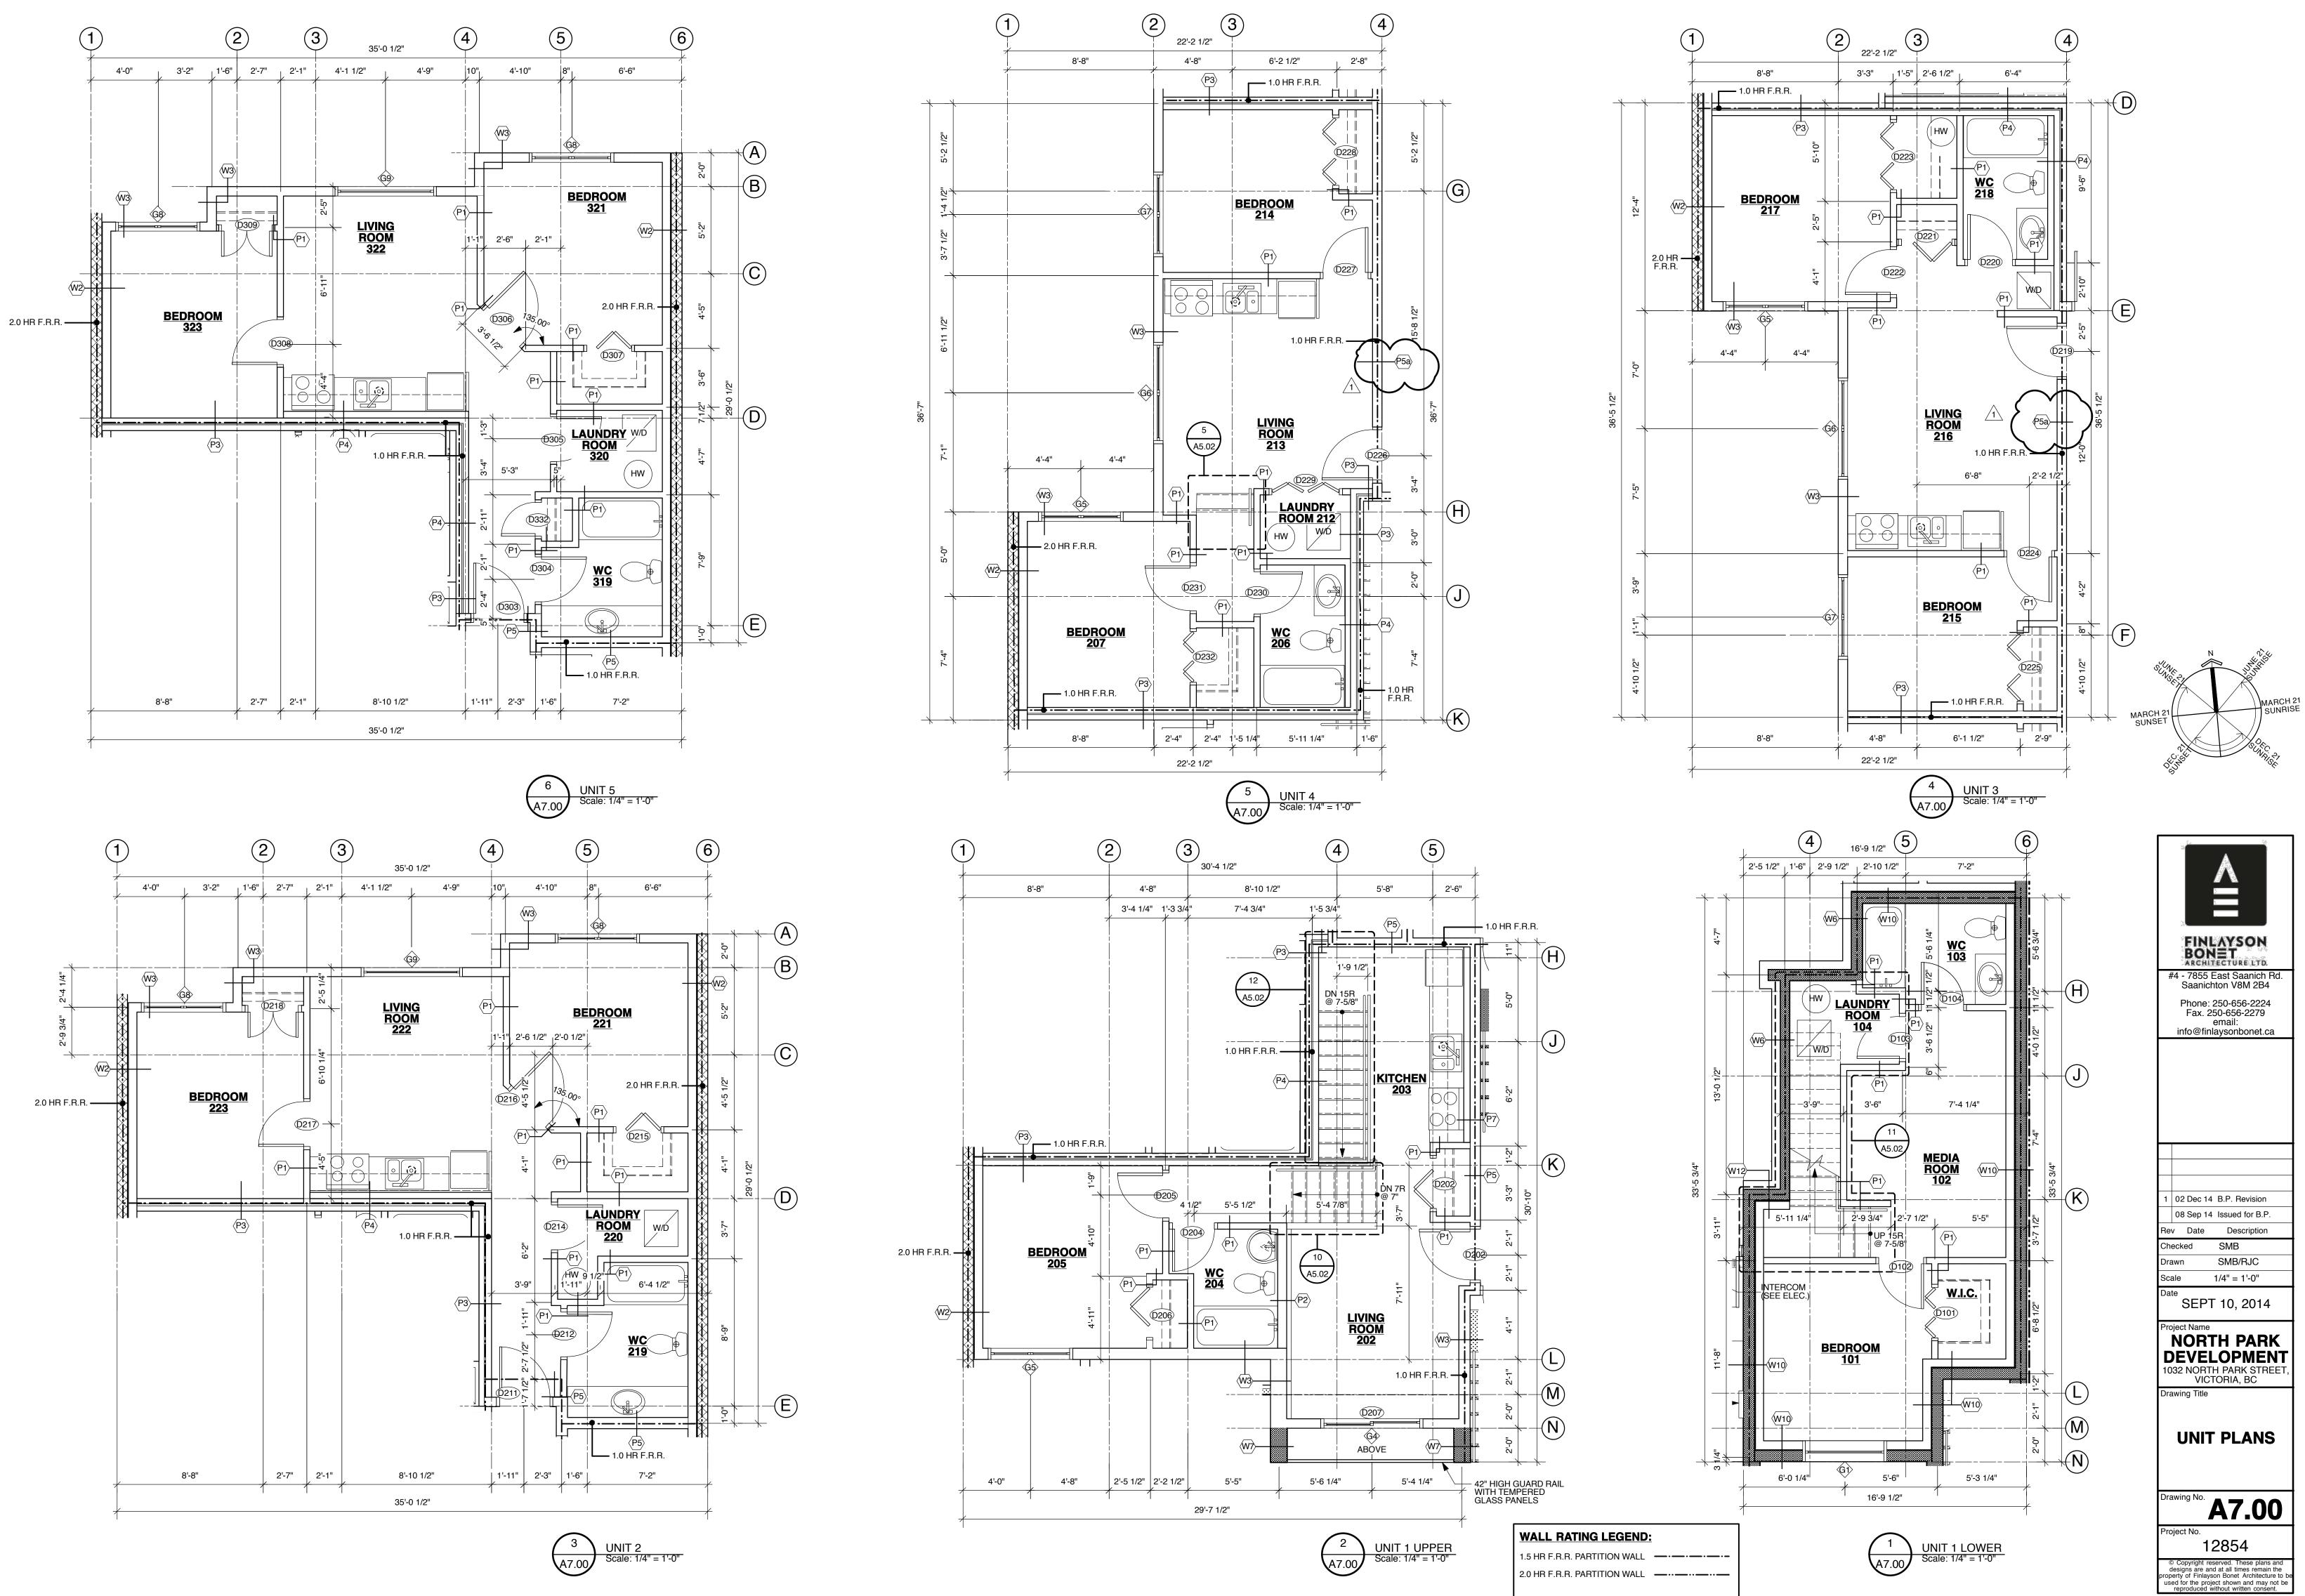

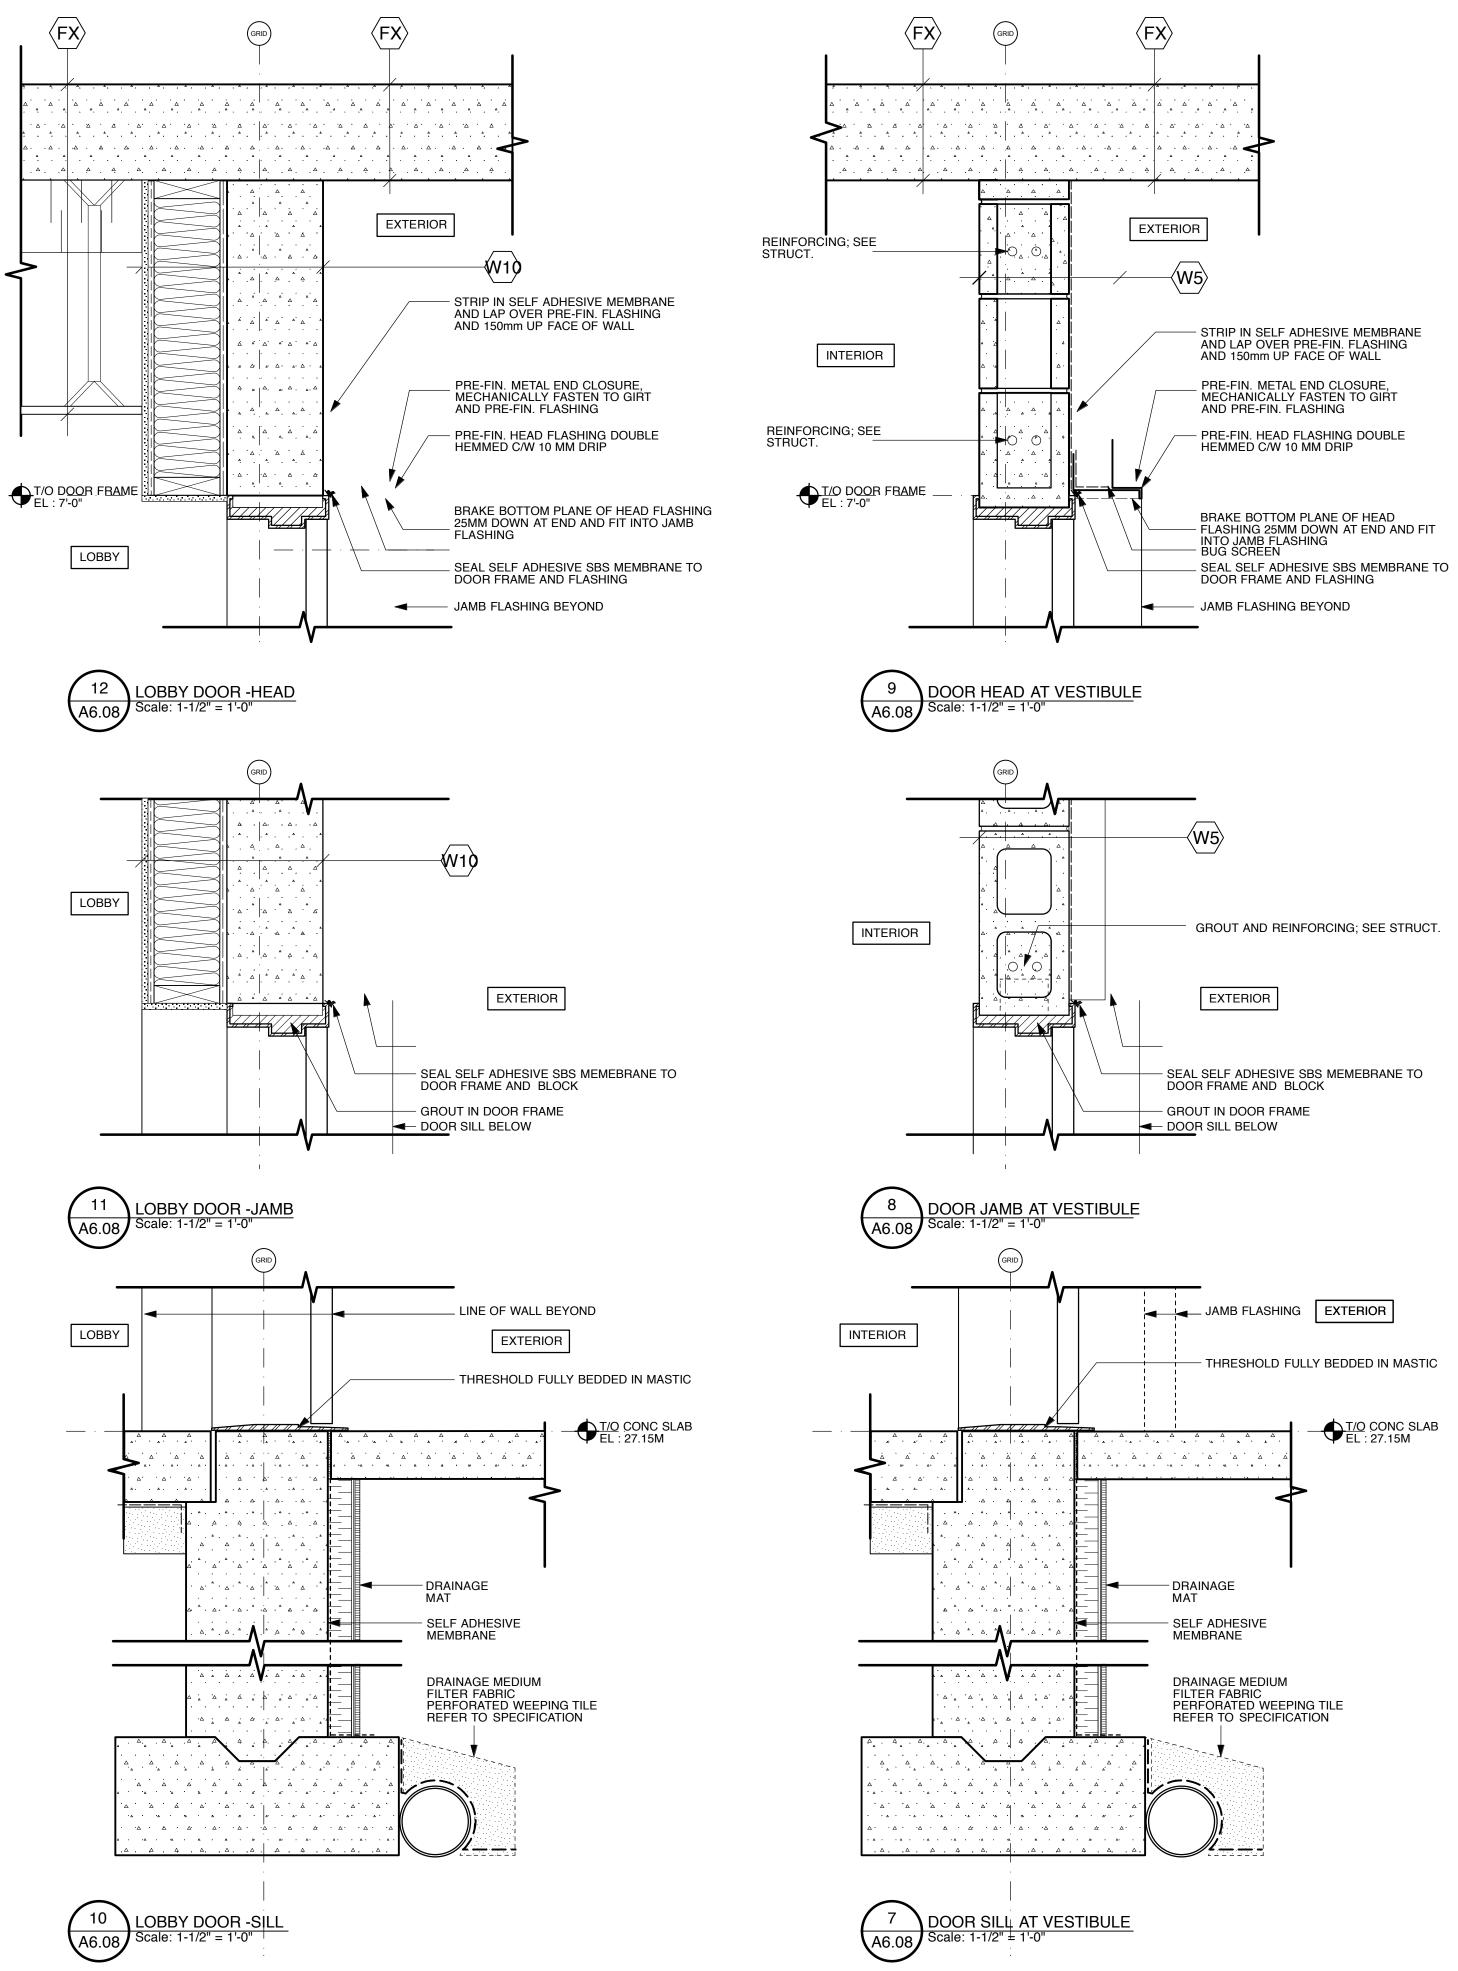

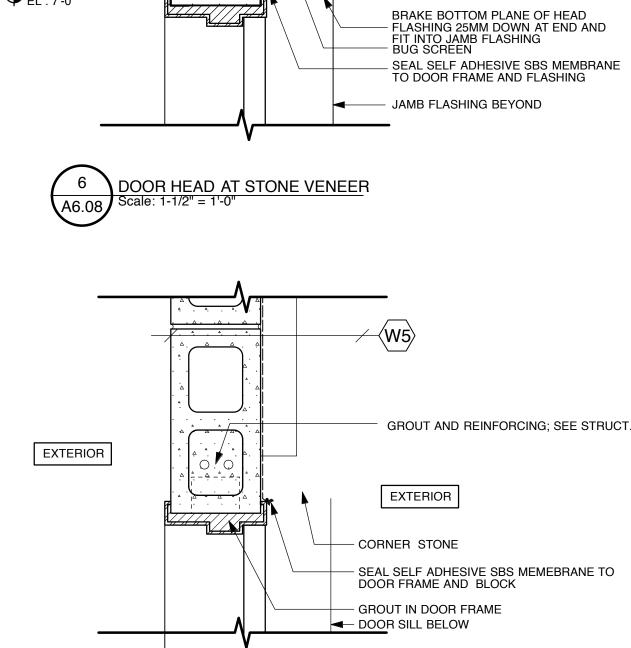

DOOR JAMB AT STONE VENEER

EXTERIOR

CONCRETE VENEER BEYOND

-WALKWAY SLOPE DOWN FROM

- THRESHOLD FULLY BEDDED IN MASTIC

- T<u>/O C</u>ONC SLAB EL : 0 000mm

STREET LEVEL

-TRENCH DRAIN (SEE

MECH.)

SELF ADHESIVE

DRAINAGE MEDIUM

PERFORATED WEEPING TILE

REFER TO SPECIFICATION

FILTER FABRIC

MEMBRANE

Scale: 1-1/2" = 1'-0"

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Scale: 1-1/2" = 1'-0"

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DOOR SILL AT STONE VENEER

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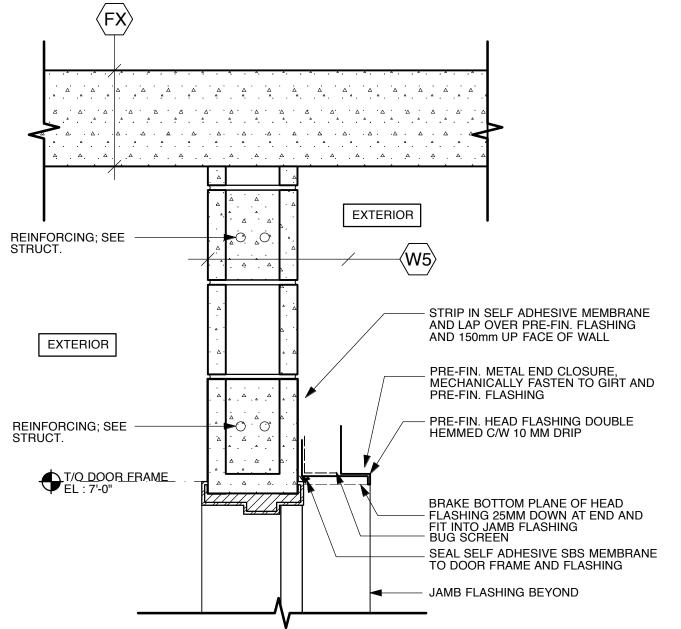
A6.08


EXTERIOR


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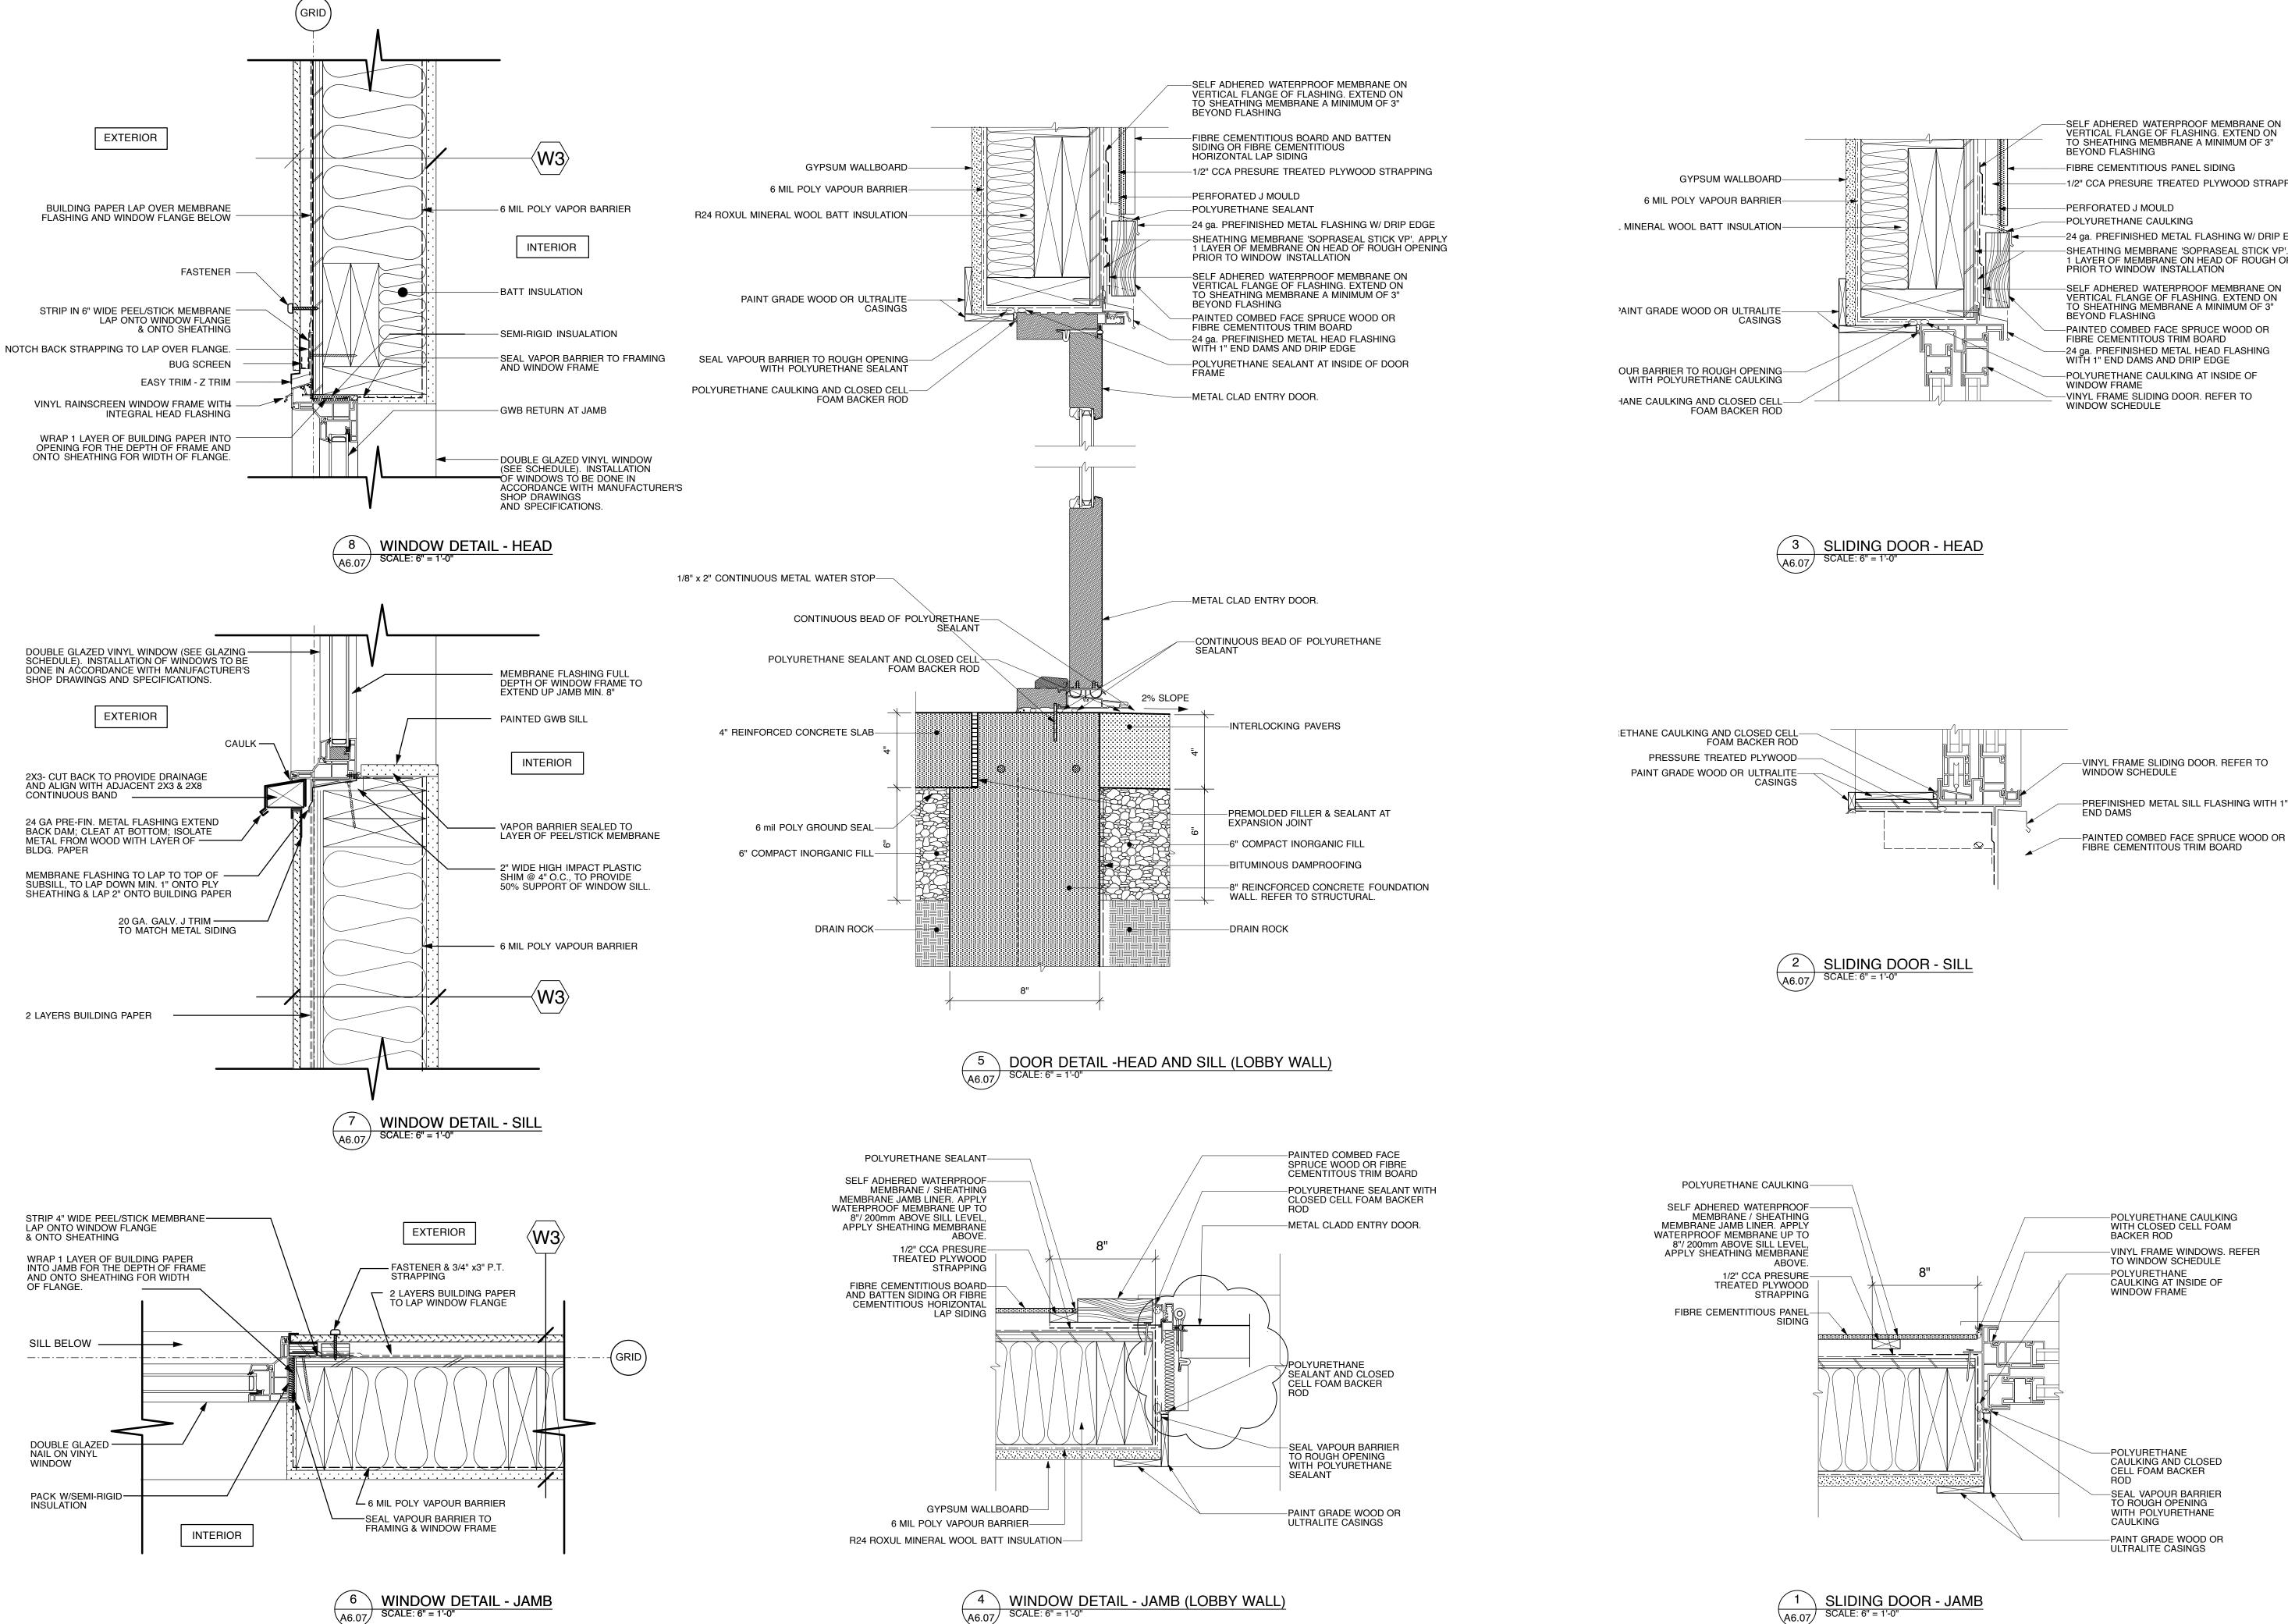
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A6.08







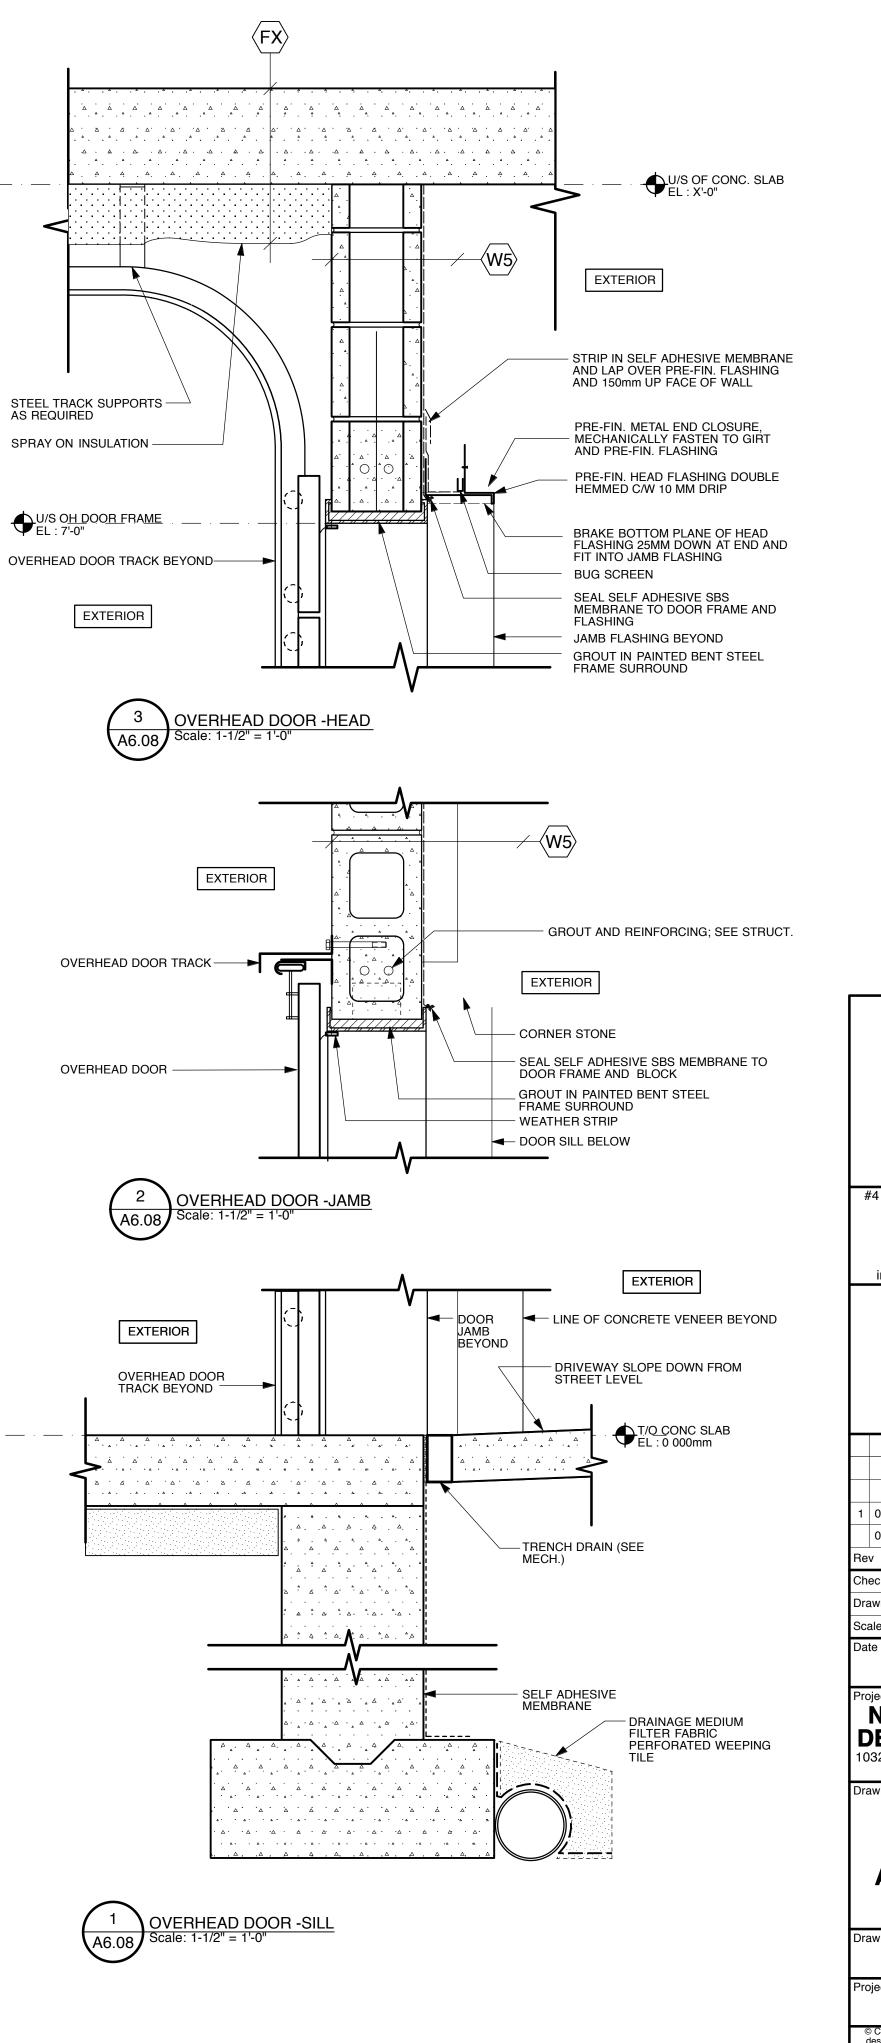

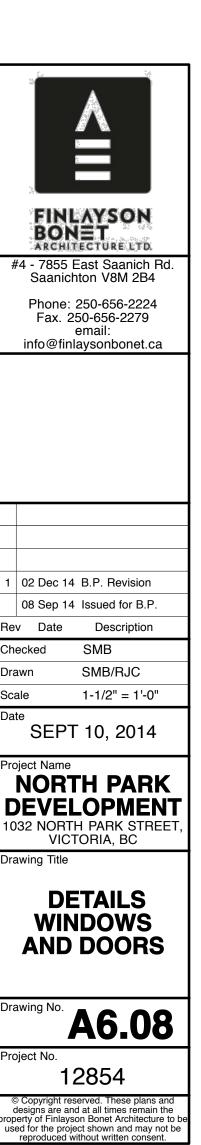SELF ADHERED WATERPROOF MEMBRANE ON VERTICAL FLANGE OF FLASHING. EXTEND ON TO SHEATHING MEMBRANE A MINIMUM OF 3"


-1/2" CCA PRESURE TREATED PLYWOOD STRAPPING


-24 ga. PREFINISHED METAL FLASHING W/ DRIP EDGE -SHEATHING MEMBRANE 'SOPRASEAL STICK VP'. APPLY 1 LAYER OF MEMBRANE ON HEAD OF ROUGH OPENING PRIOR TO WINDOW INSTALLATION


-SELF ADHERED WATERPROOF MEMBRANE ON VERTICAL FLANGE OF FLASHING. EXTEND ON TO SHEATHING MEMBRANE A MINIMUM OF 3"


—24 ga. PREFINISHED METAL HEAD FLASHING WITH 1" END DAMS AND DRIP EDGE

-VINYL FRAME SLIDING DOOR. REFER TO WINDOW SCHEDULE -PREFINISHED METAL SILL FLASHING WITH 1"

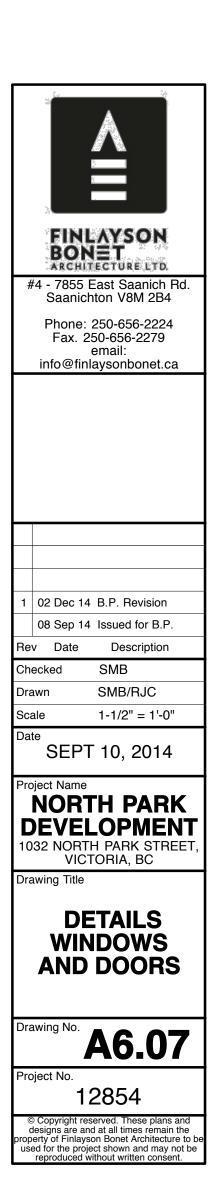


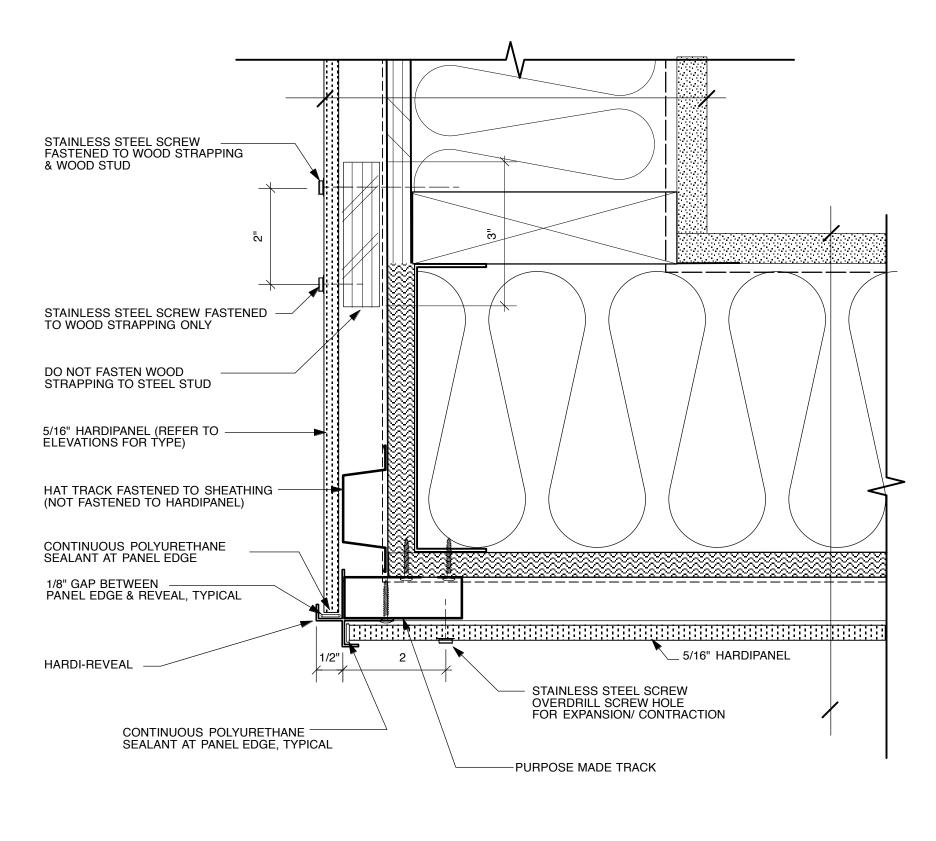

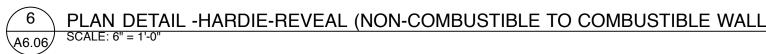


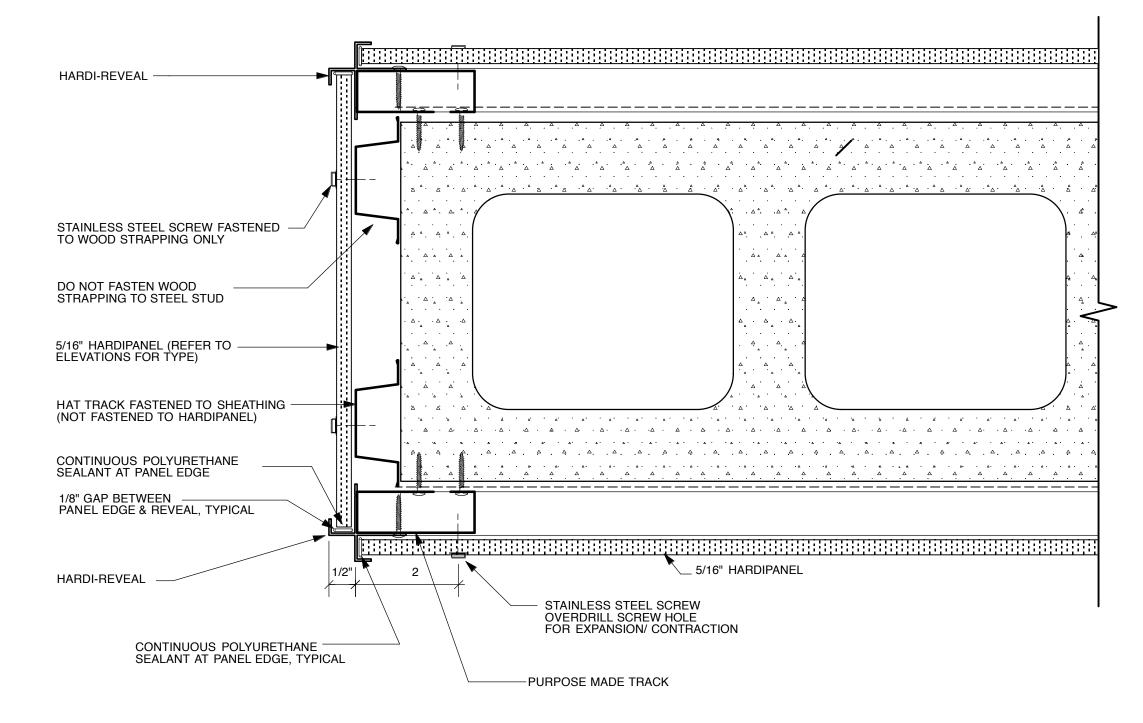


5 PLAN DETAIL -HARDIE-REVEAL ON CONC. BLOCK FIN WALL A6.06 SCALE: 6" = 1'-0"

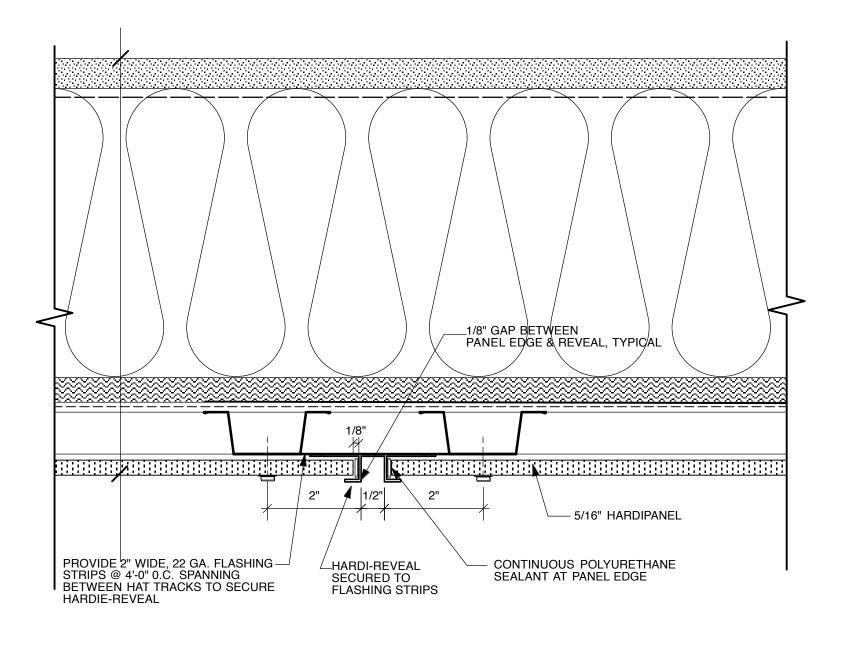

A6.06 SCALE: 6" = 1'-0"

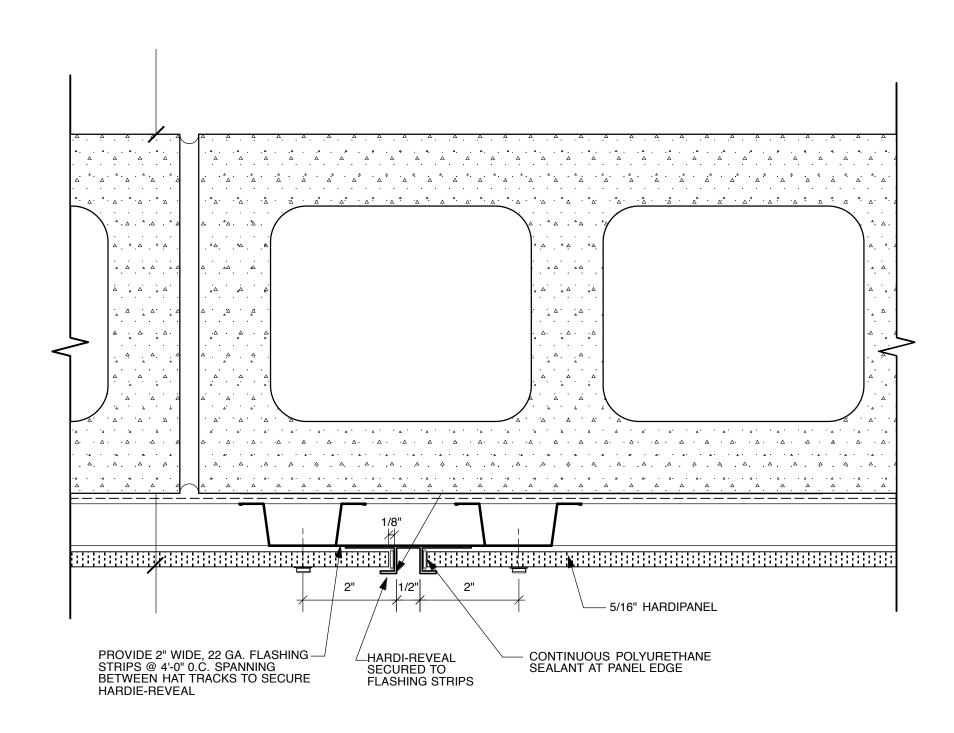

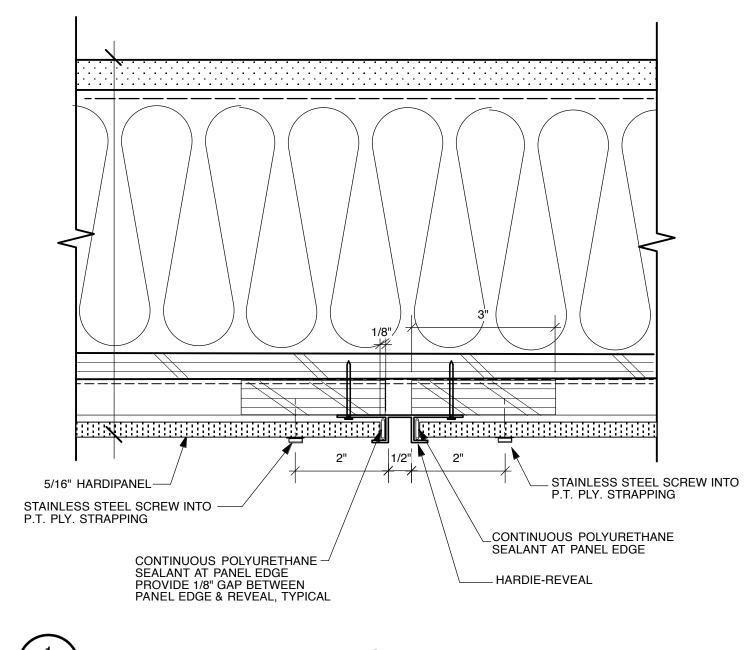


3 PLAN DETAIL -HARDIE-REVEAL ON CMU SCALE: 6" = 1'-0"

A6.06




A6.06

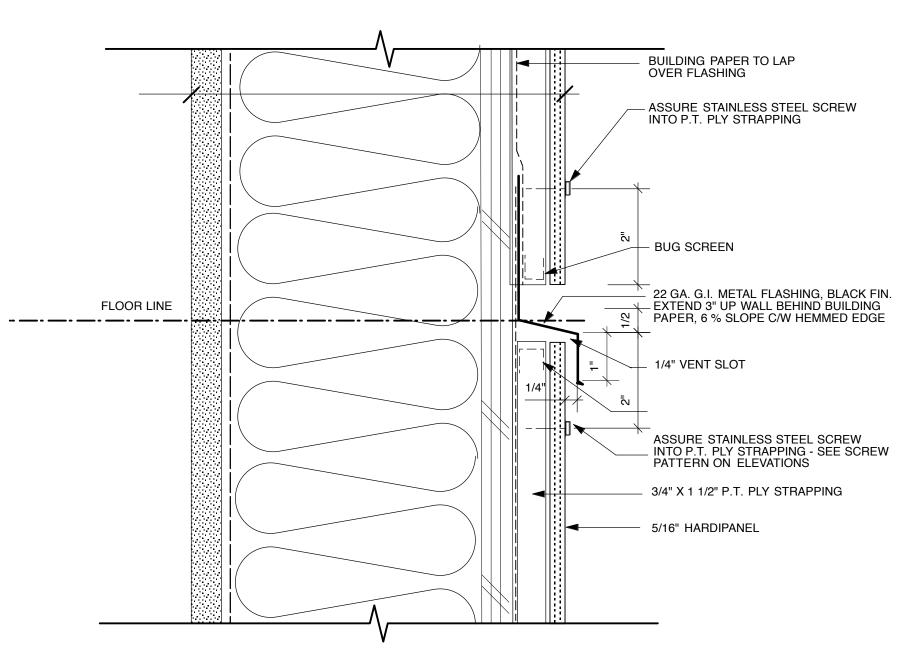





A6.06

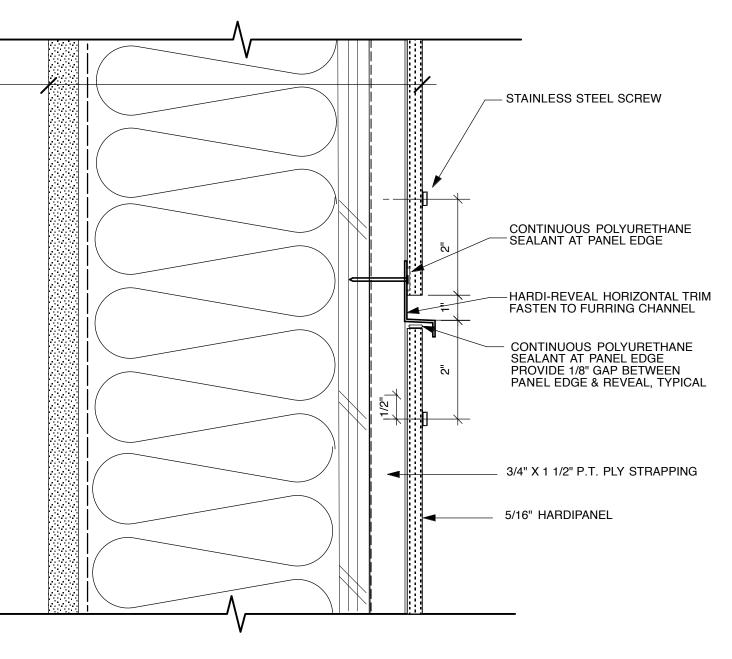

SECTION DETAIL -HARDIE-REVEAL (TYPICAL) Scale: 6" = 1'-0"

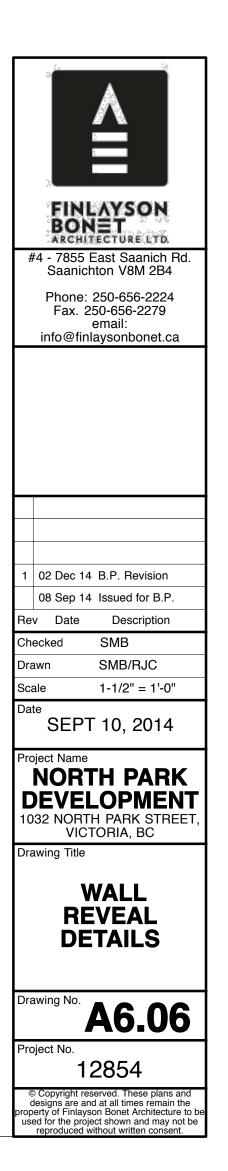

PLAN DETAIL -HARDIE REVEAL (TYPICAL) Scale: 6" = 1'-0"

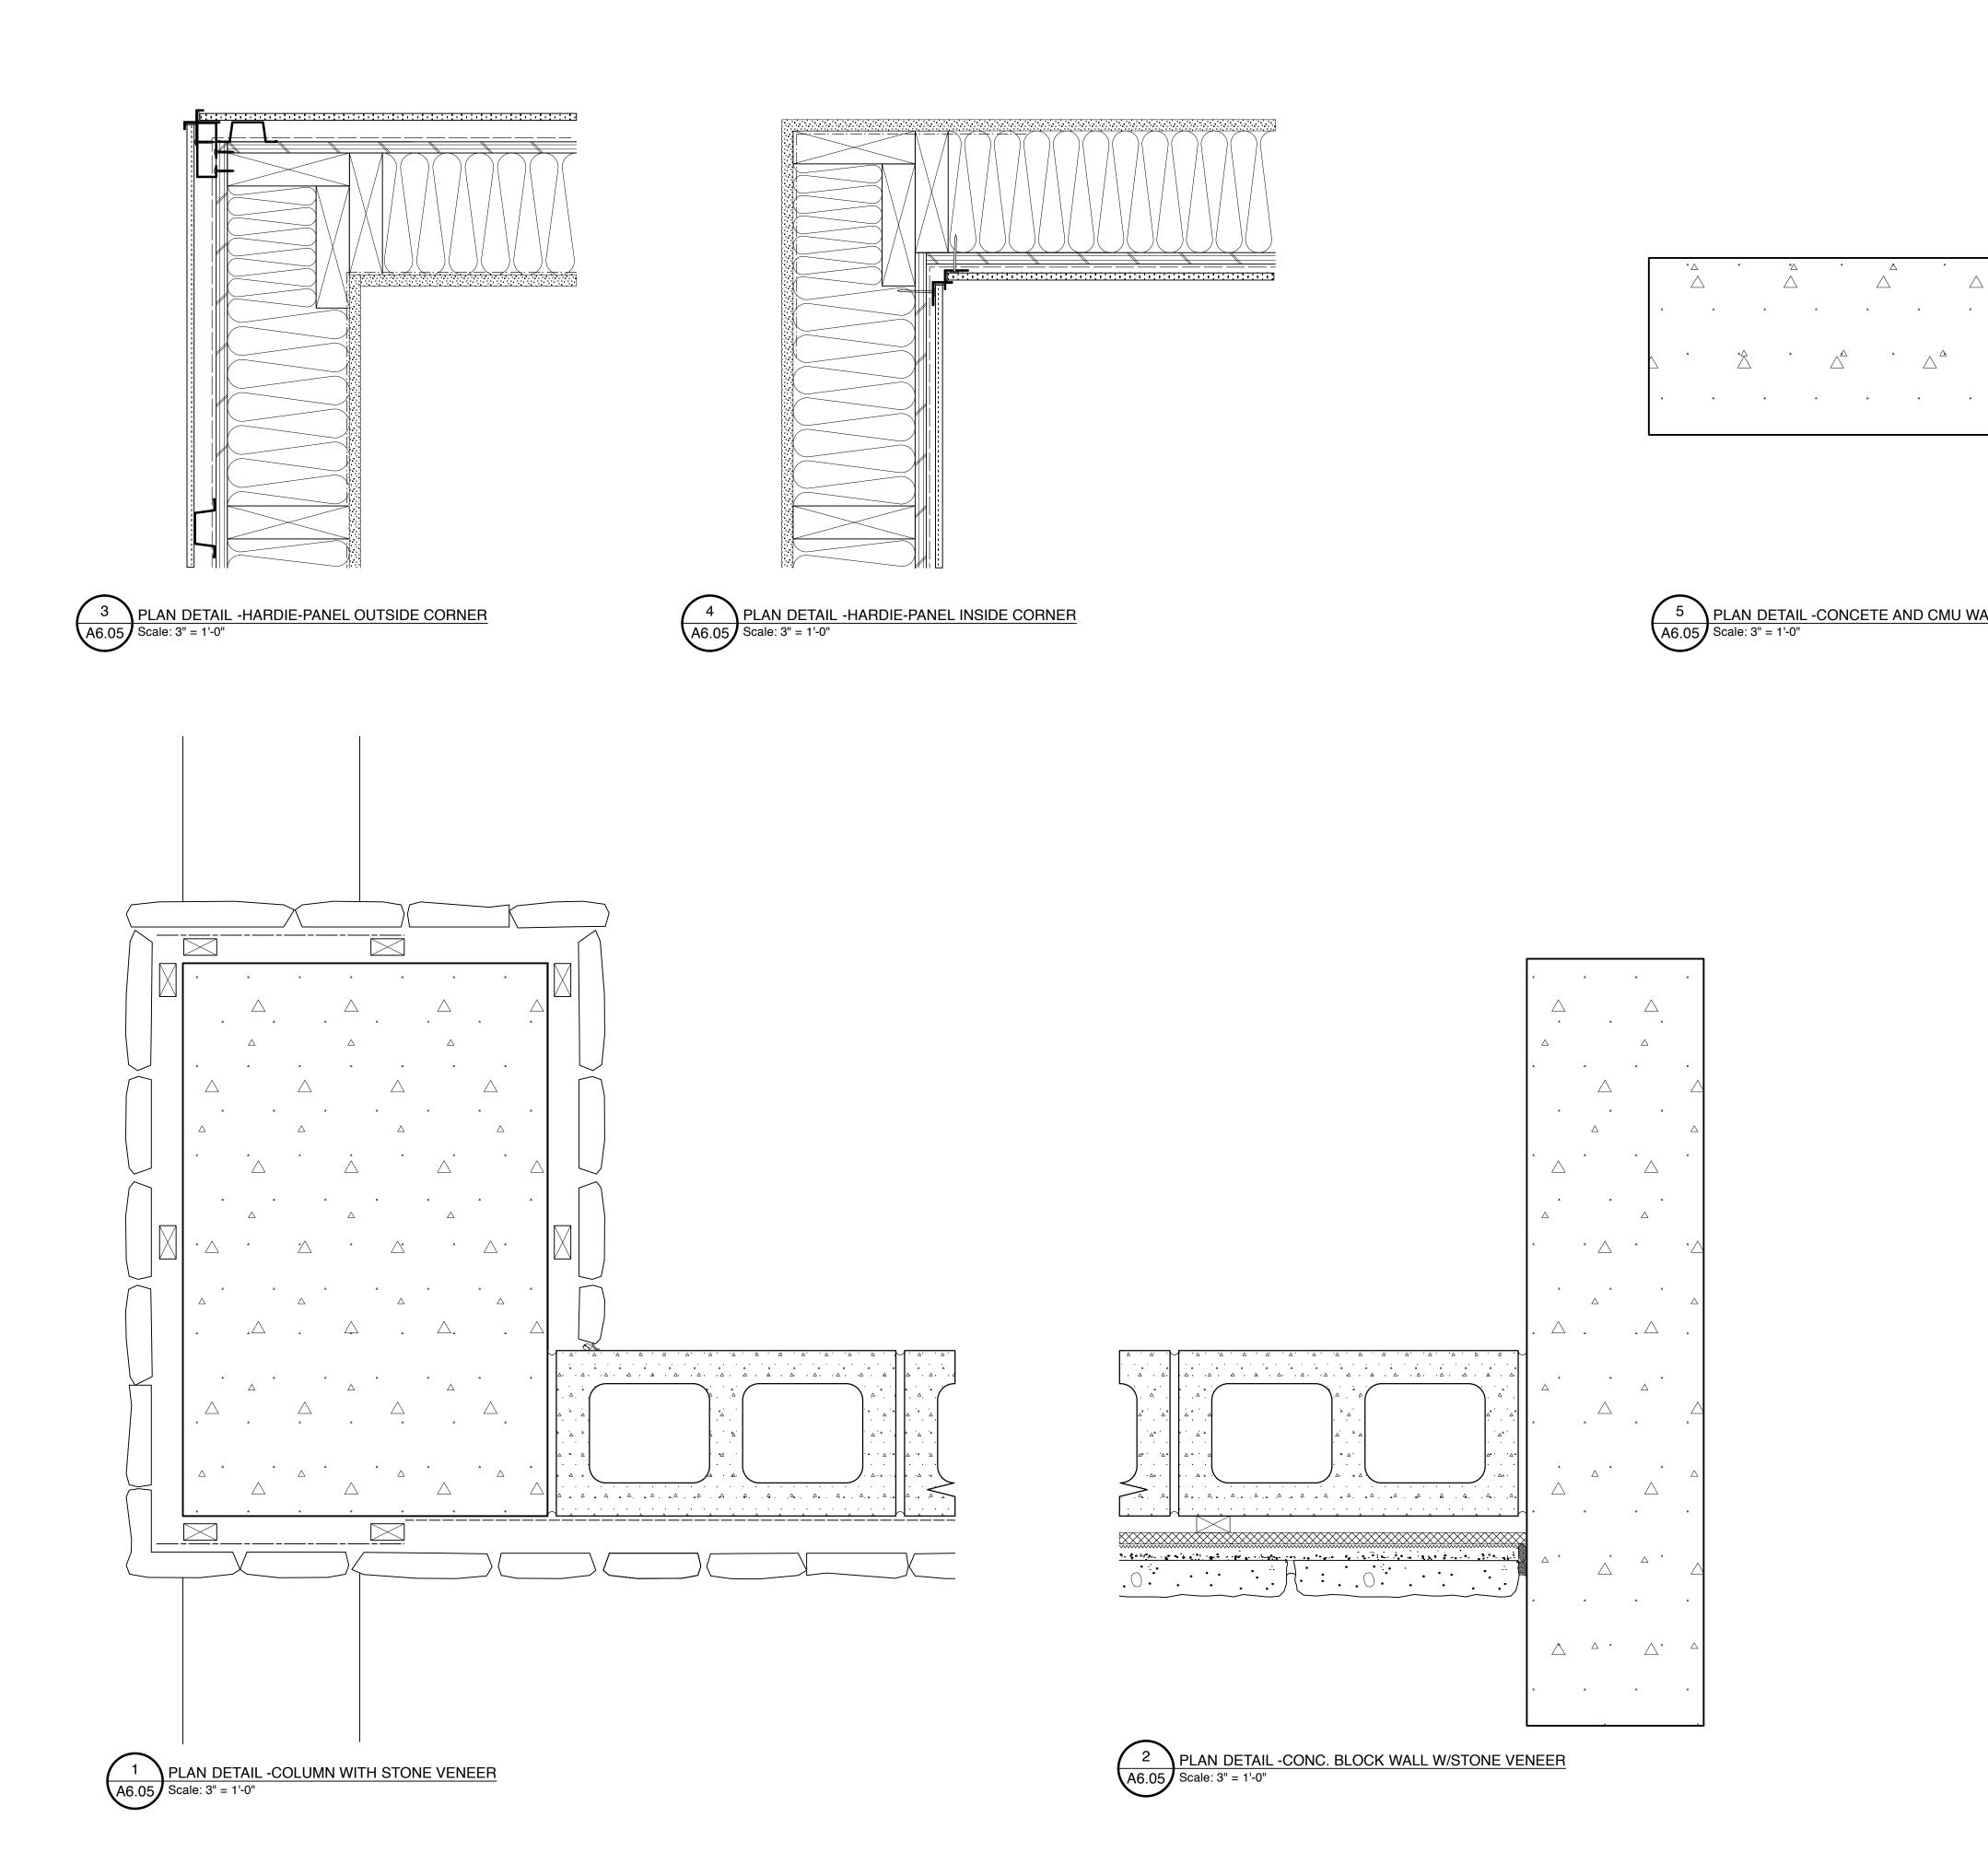




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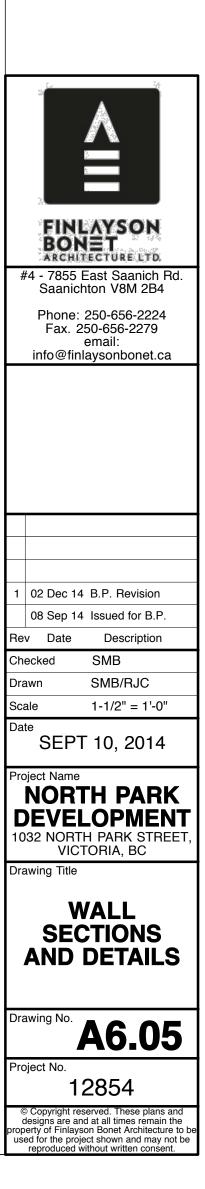
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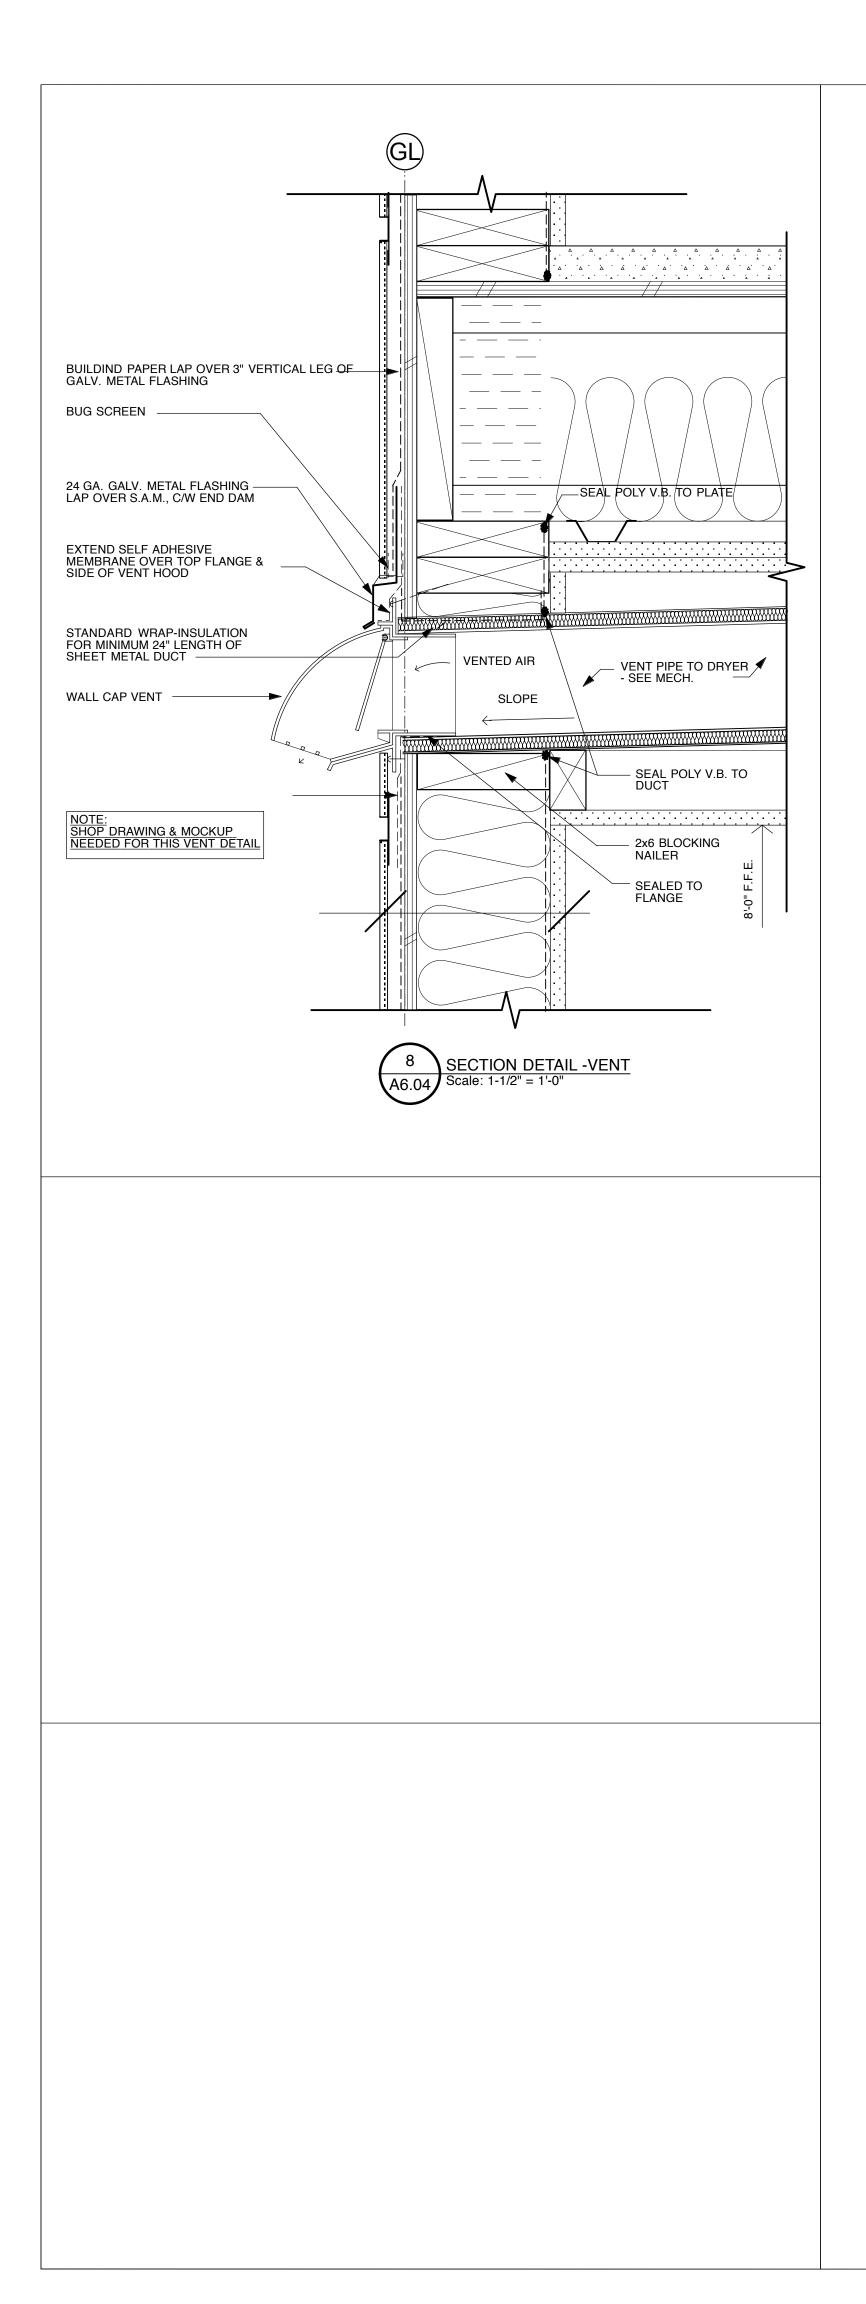
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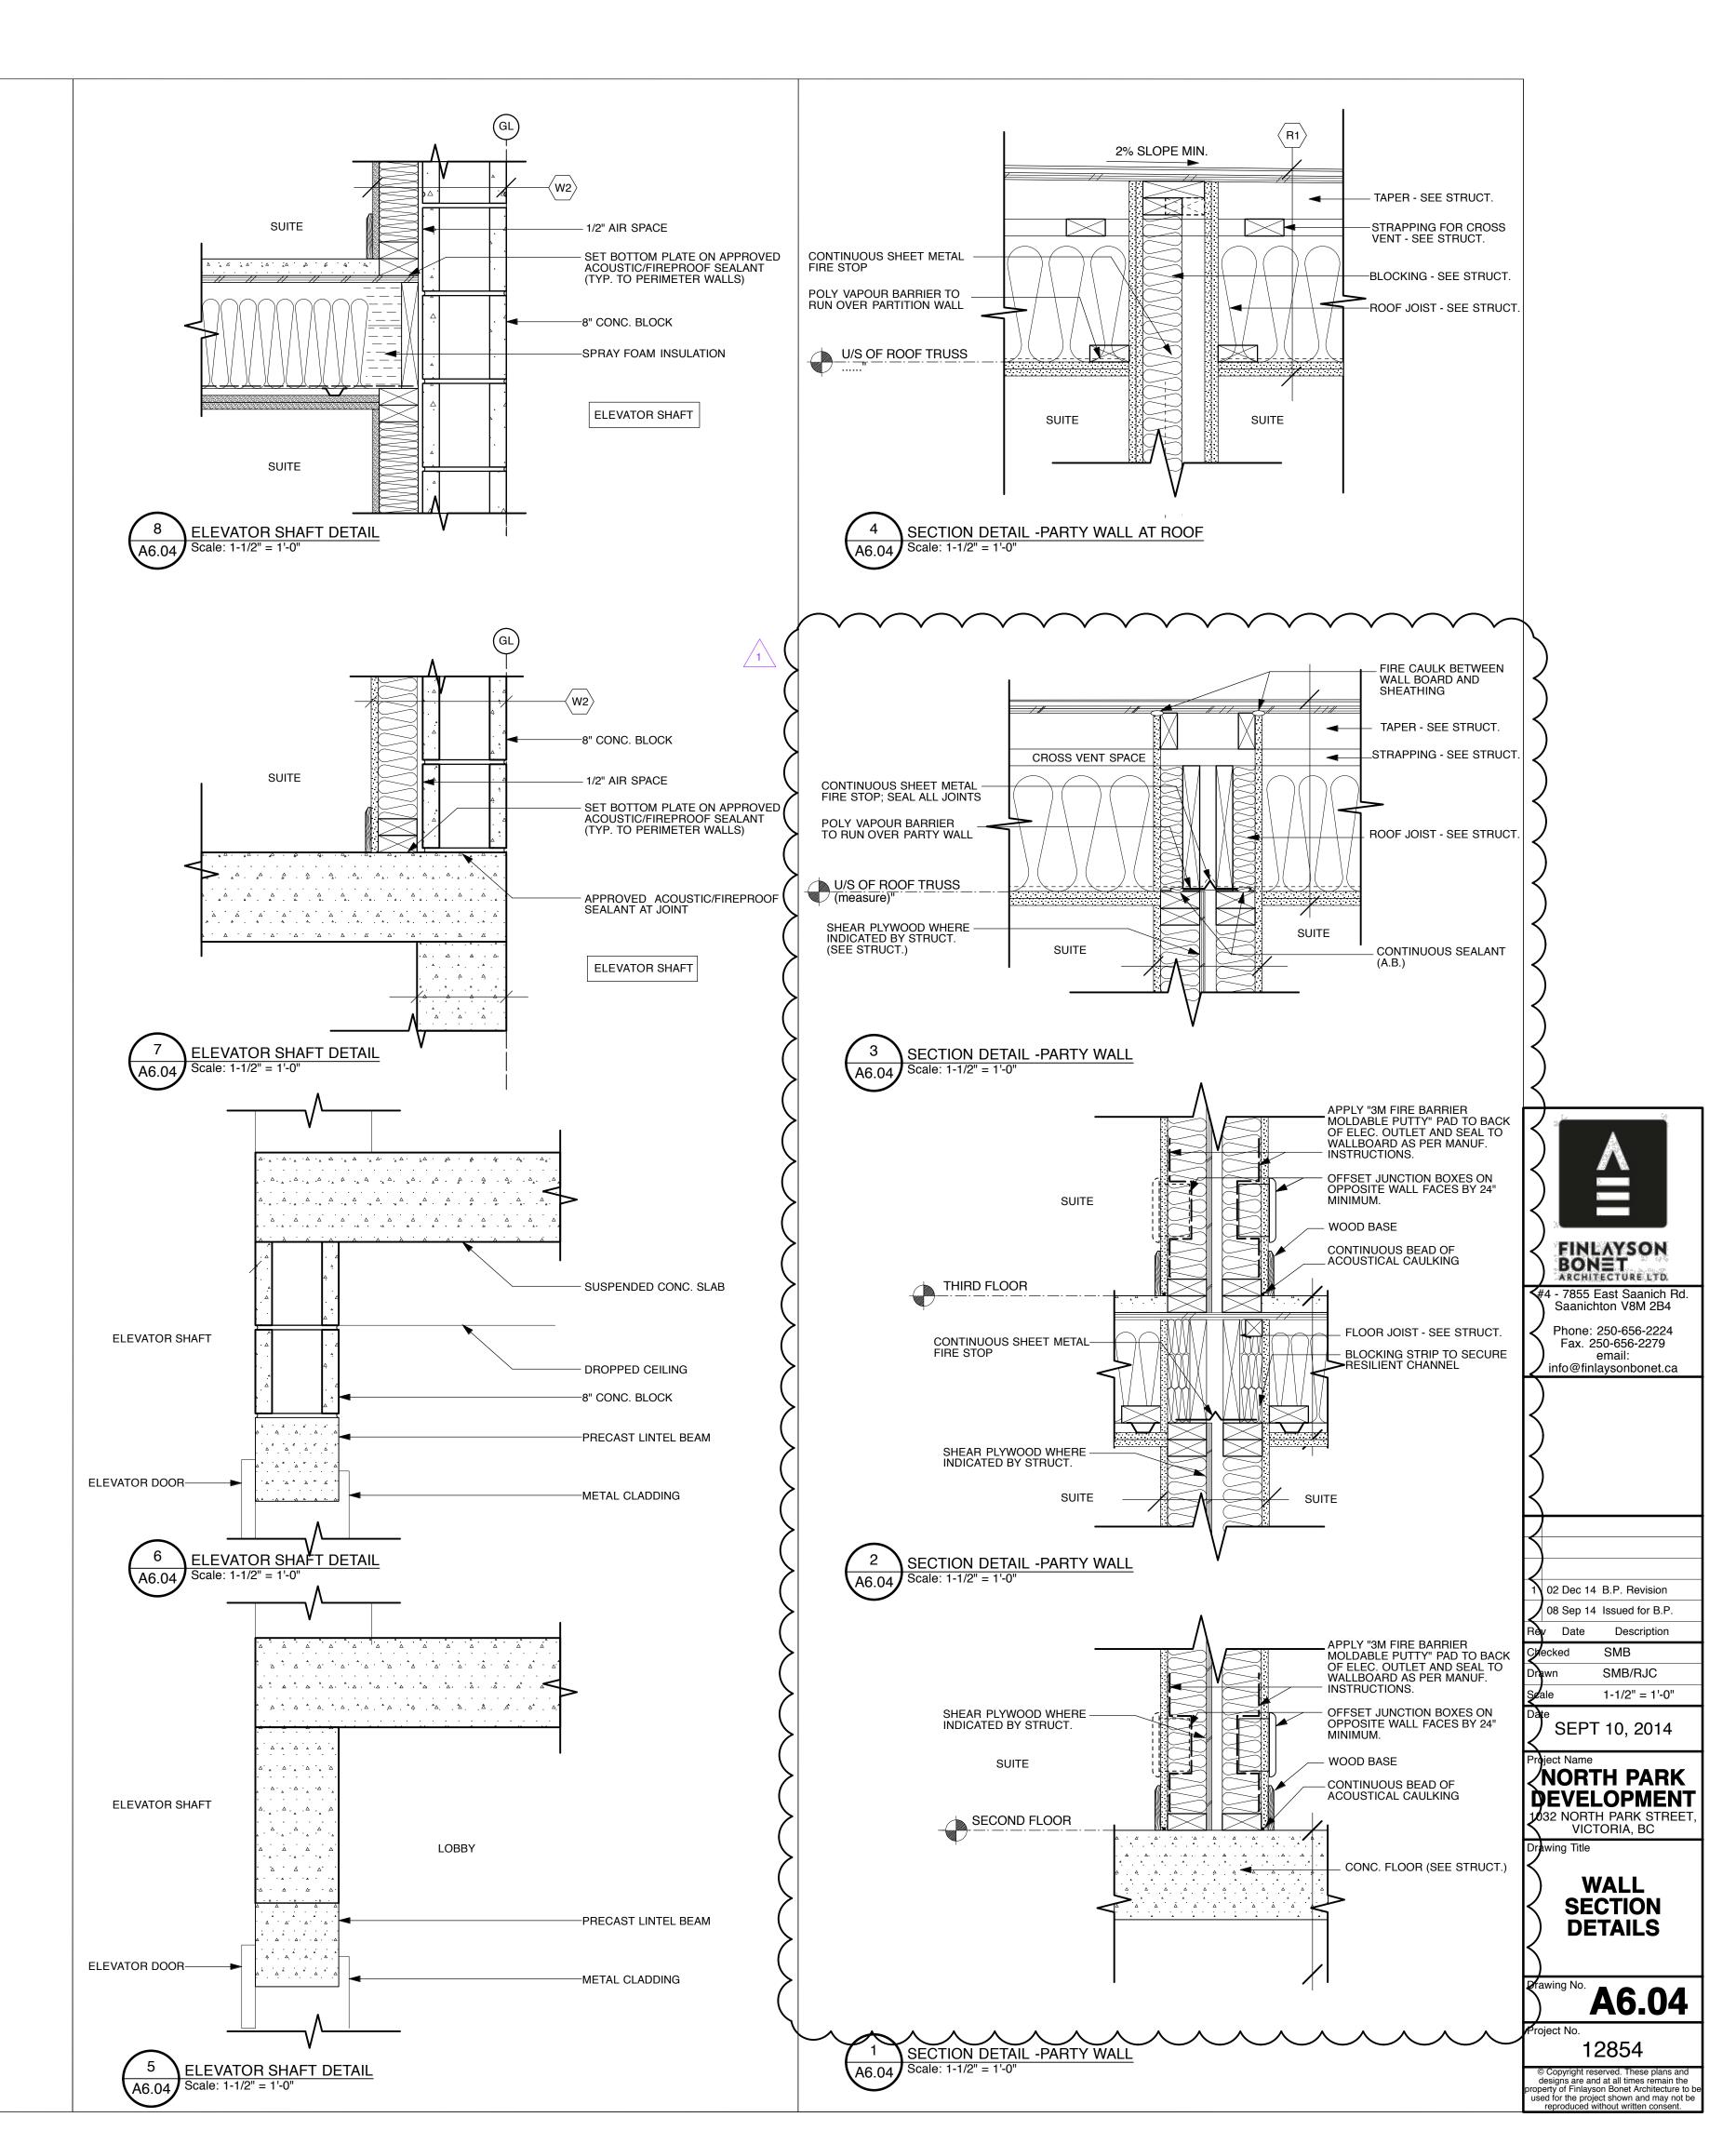
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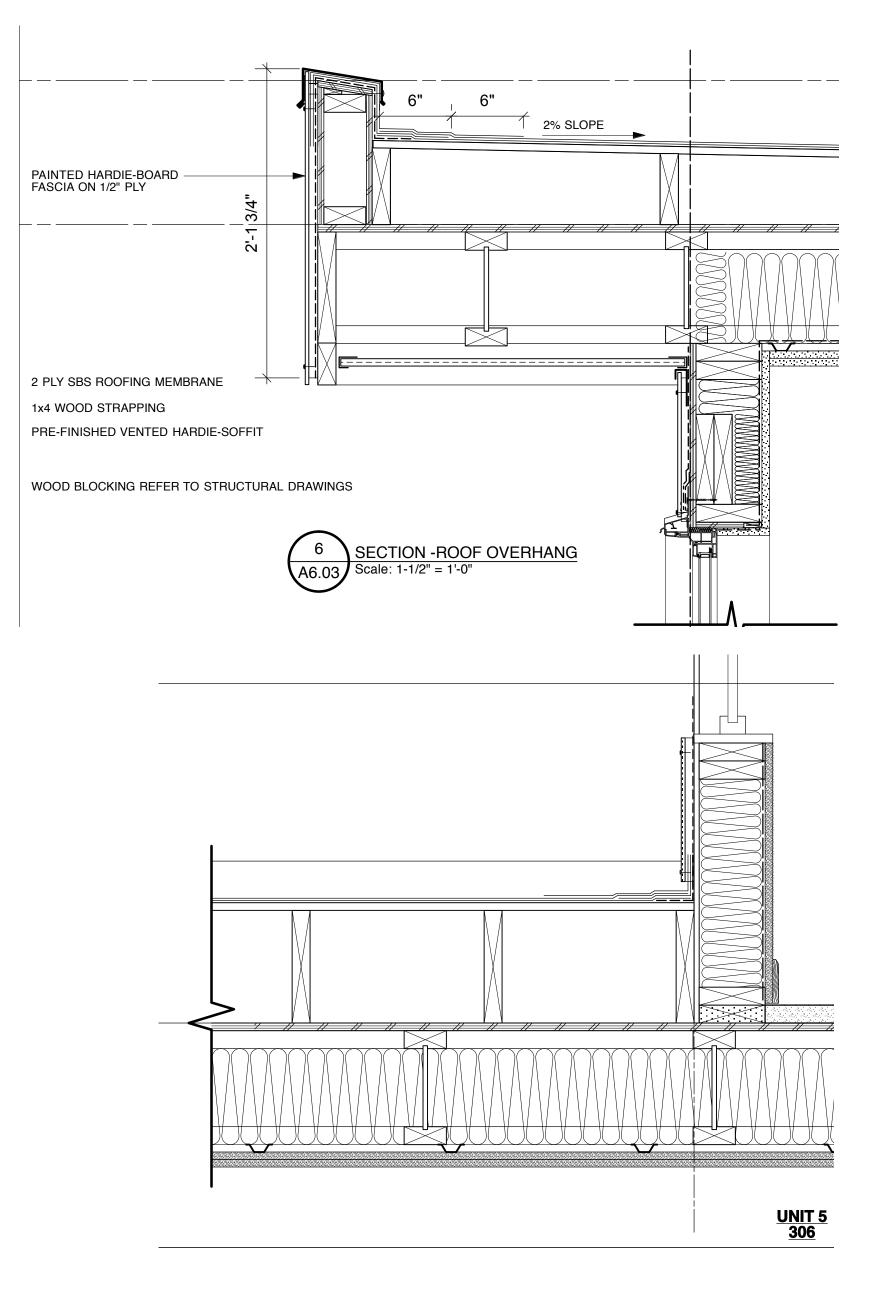
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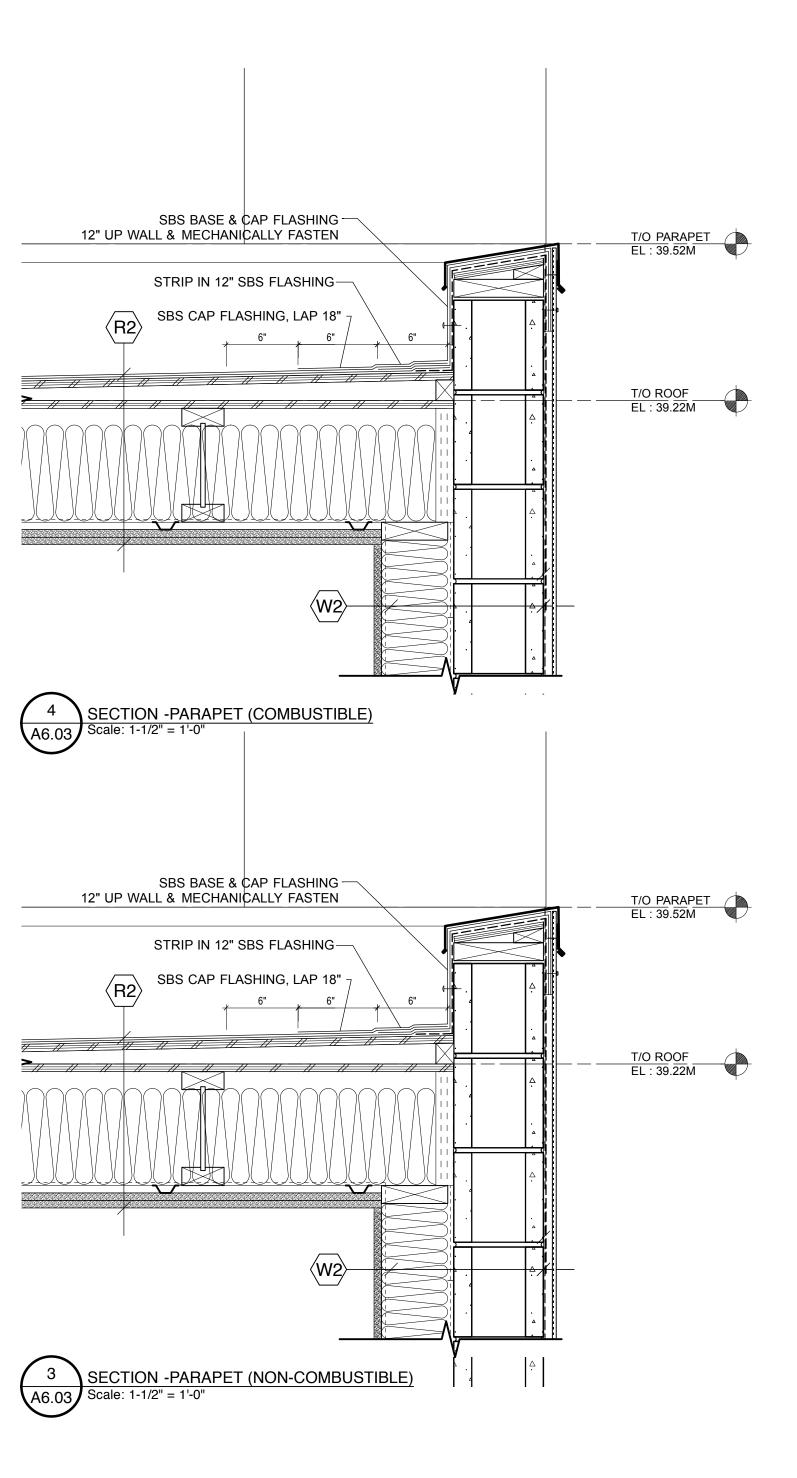










5 SECTION -WALL AT FLAT ROOF A6.03 Scale: 1-1/2" = 1'-0"

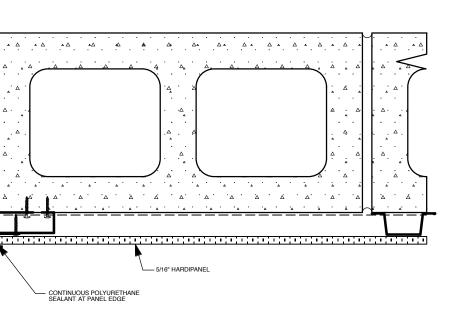


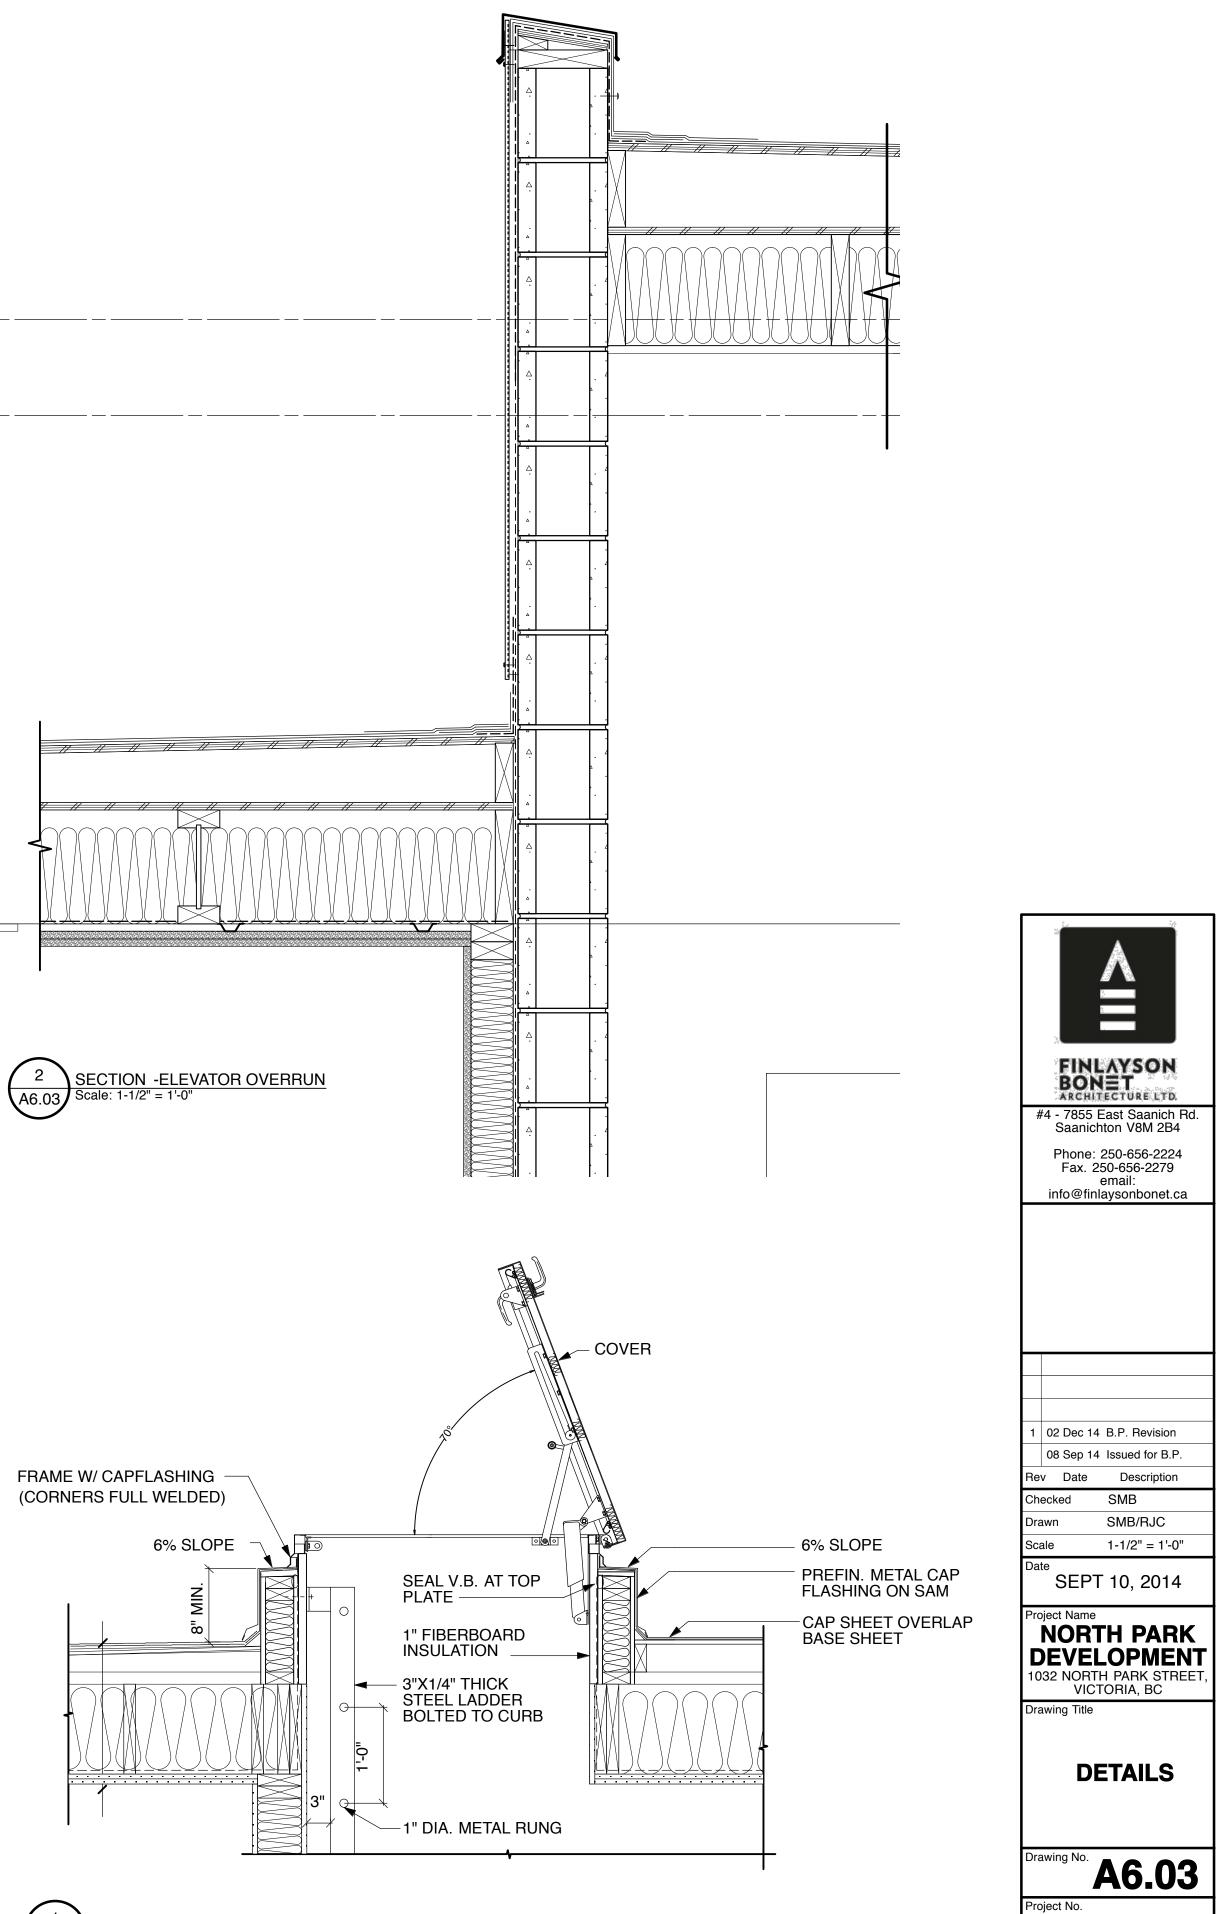


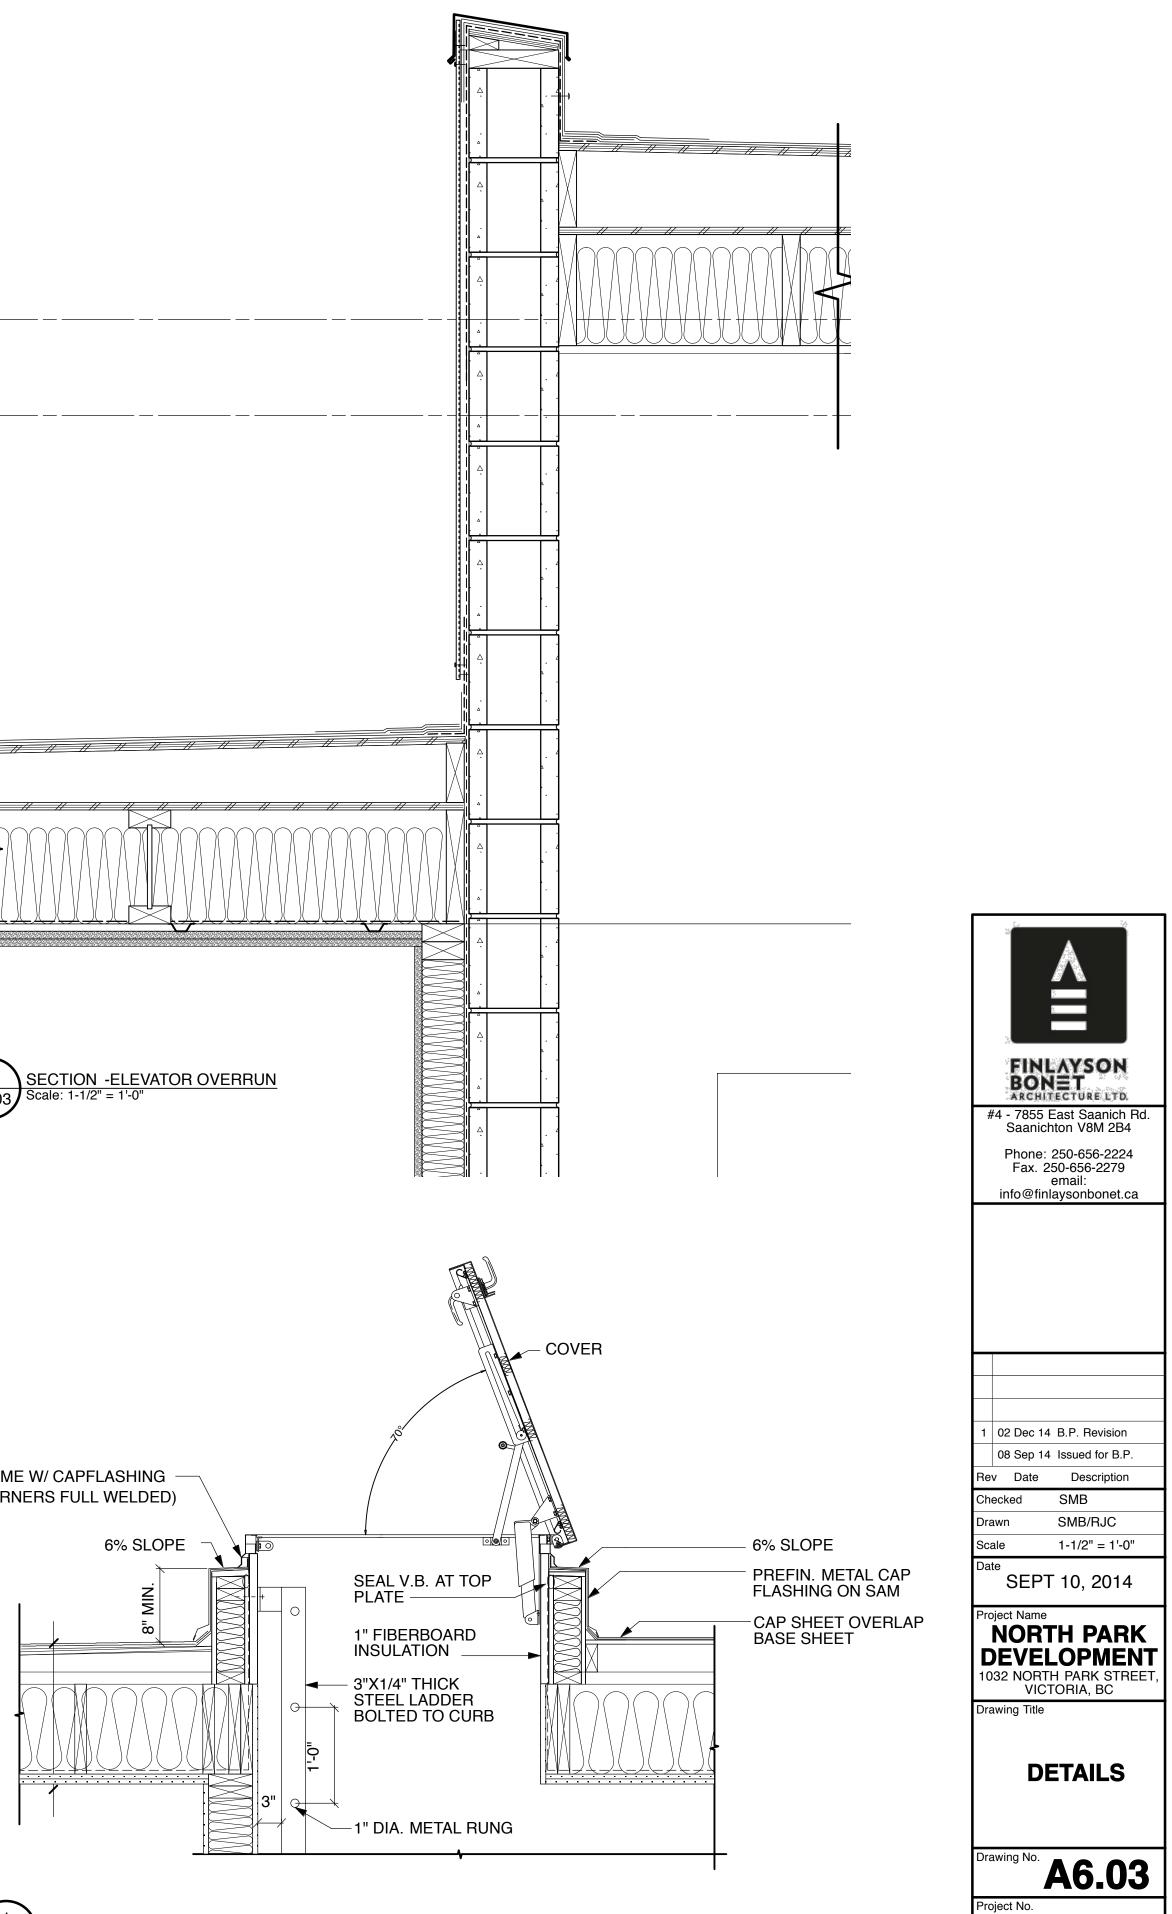





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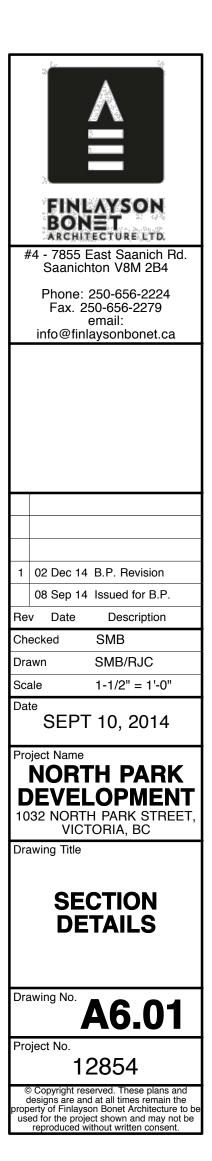


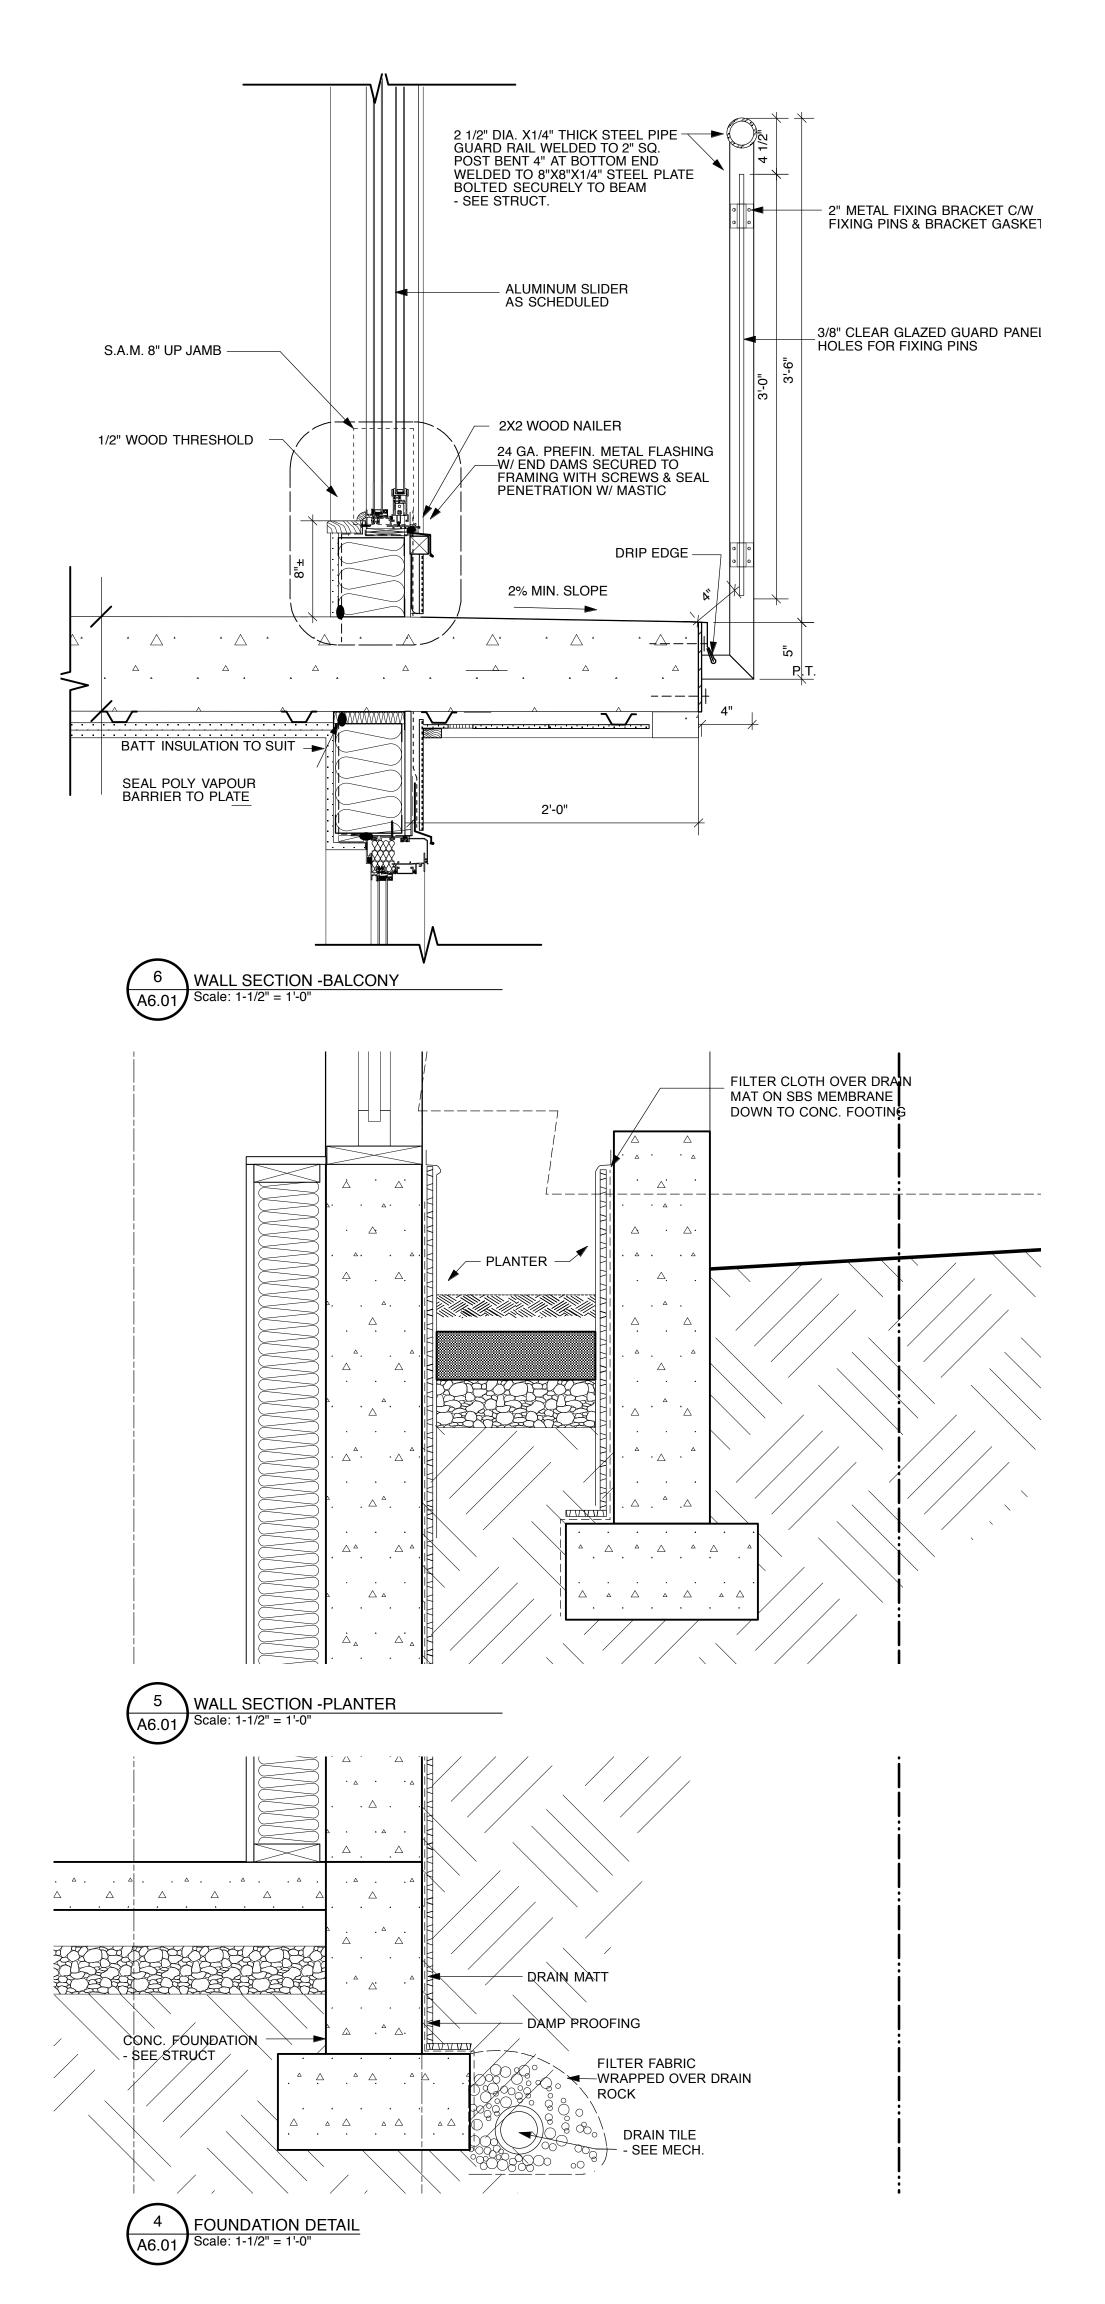


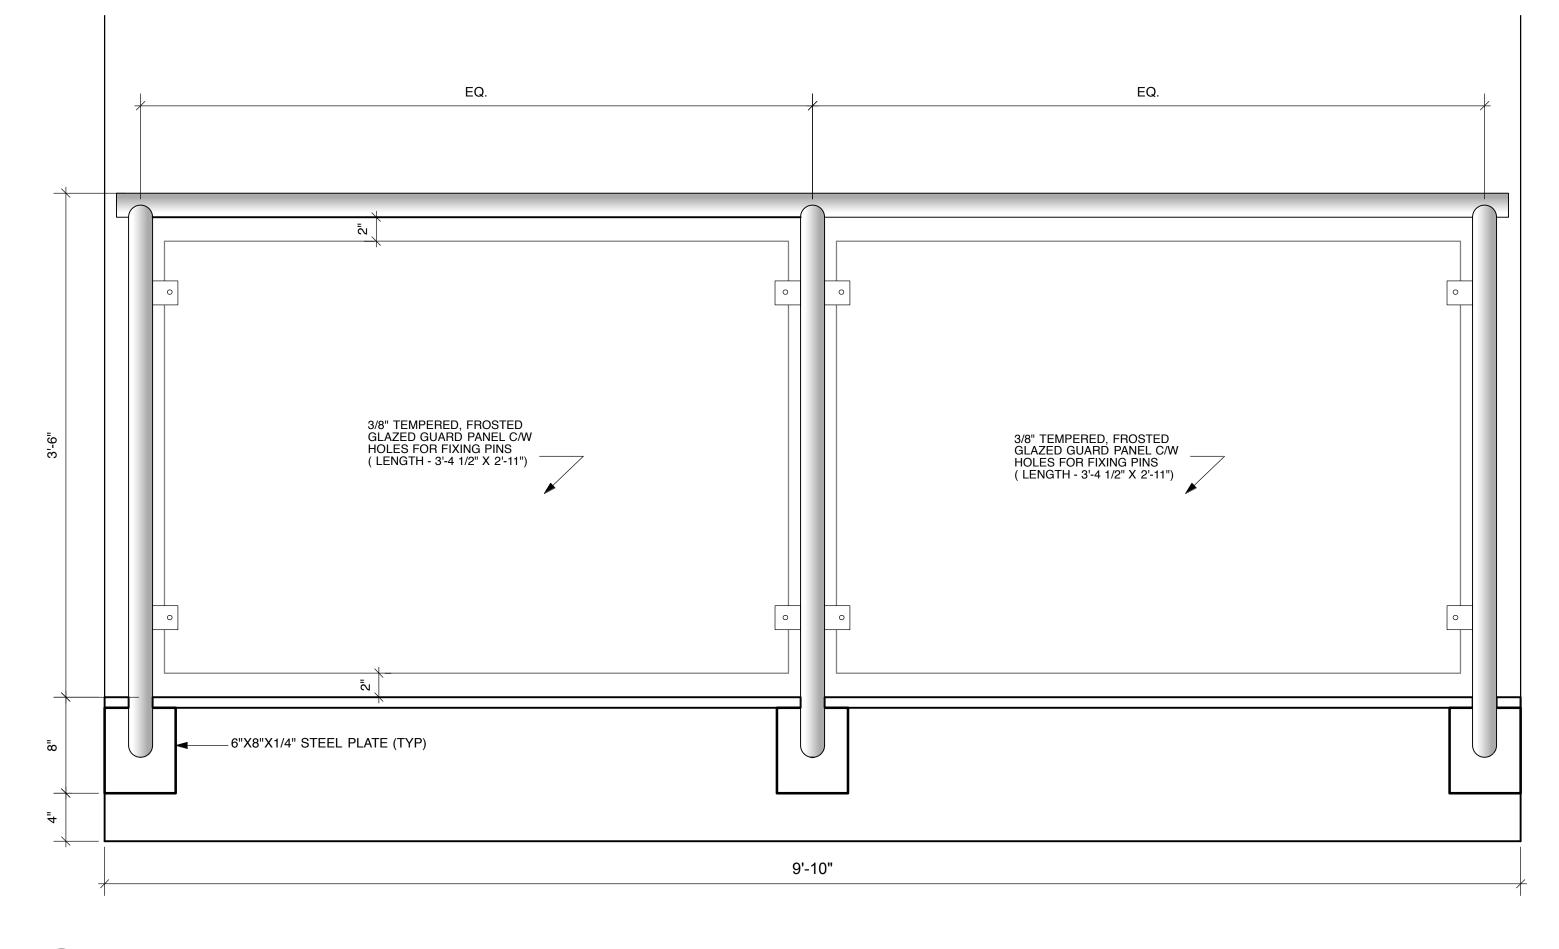3 DETAIL -BALCONY RAILING A6.01 Scale: 1-1/2" = 1'-0"



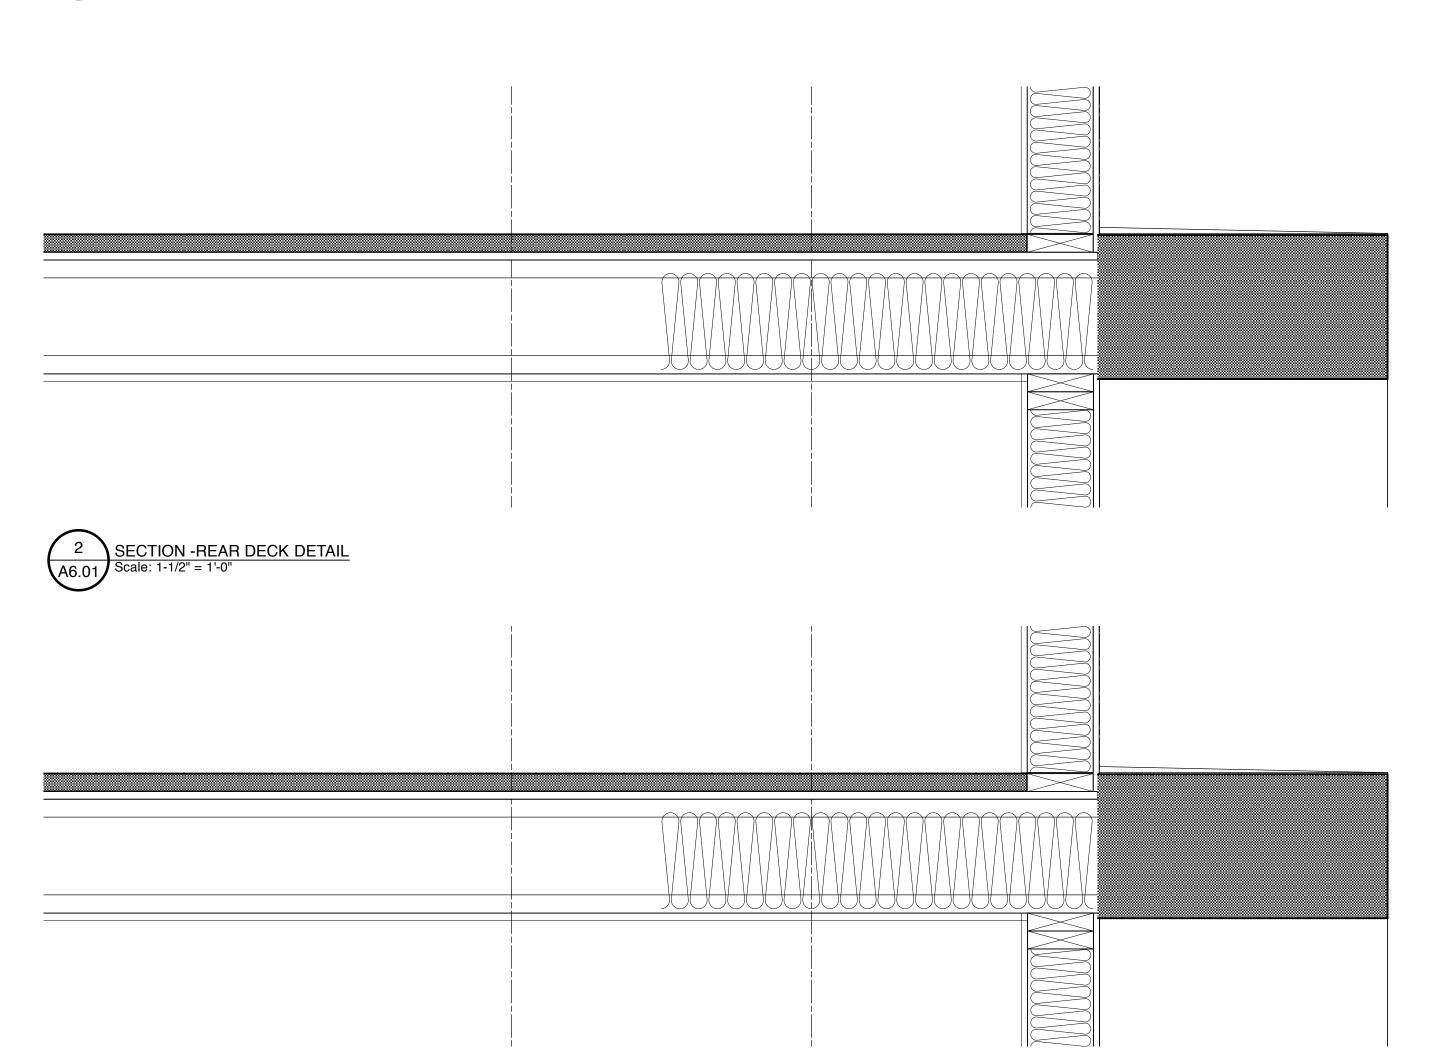

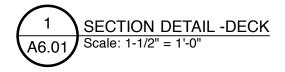

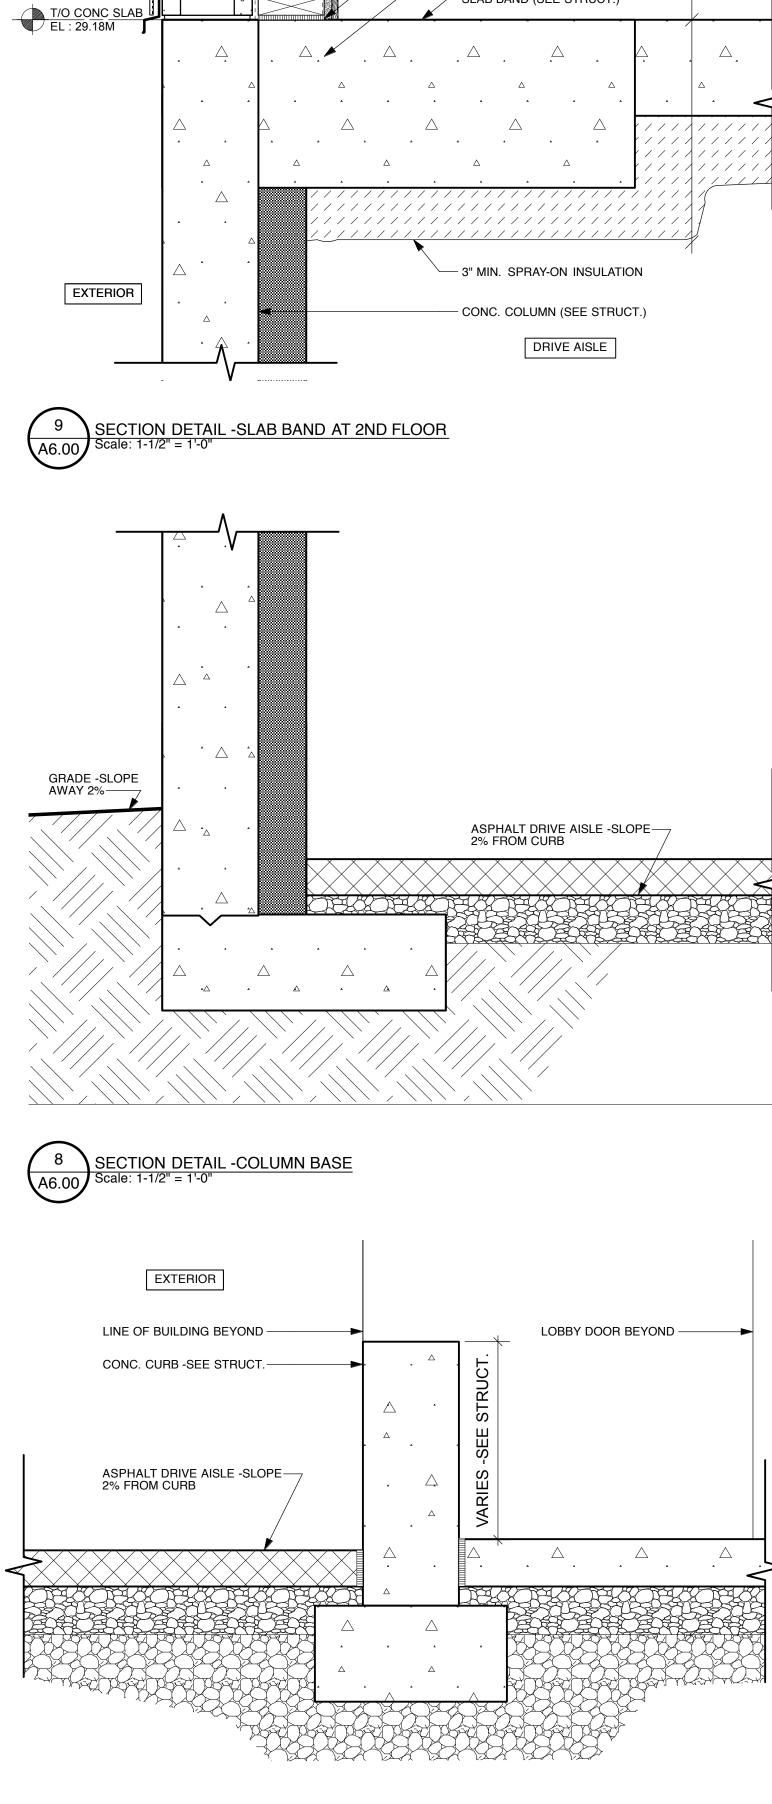

SEAL VAPOUR BARRIER TO PLATE

UNIT 1

(F3)

- BASEBOARD AS SPECIFIED


- CLOSED CELL FOAM GASKET

- SLAB BAND (SEE STRUCT.)

- FLOOR FINISH AS SPECIFIED


(W2)



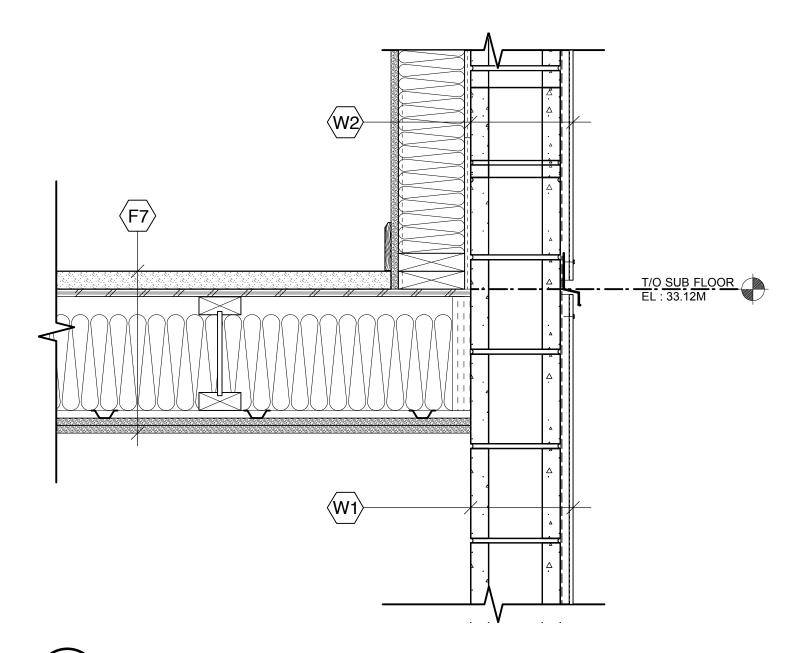


SECTION DETAIL -FLOOR AT CMU EXTERIOR WALL


A6.00

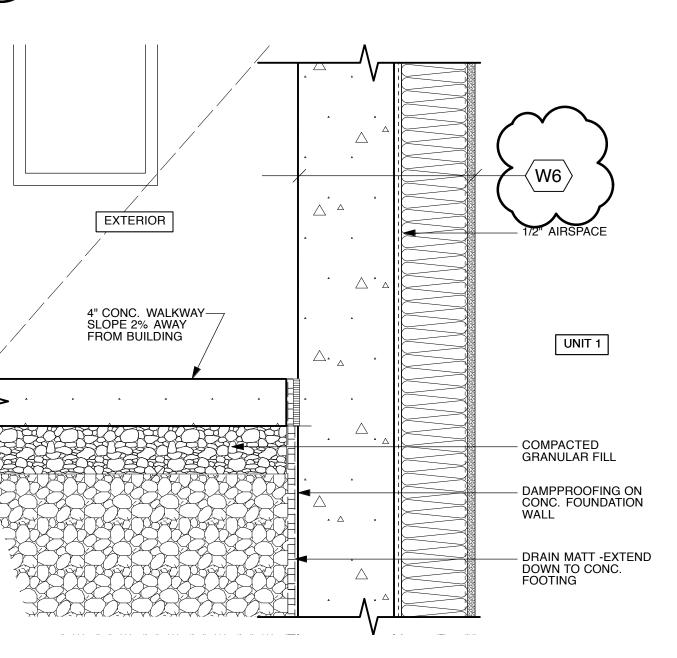

5 Scale: 1-1/2" = 1'-0"

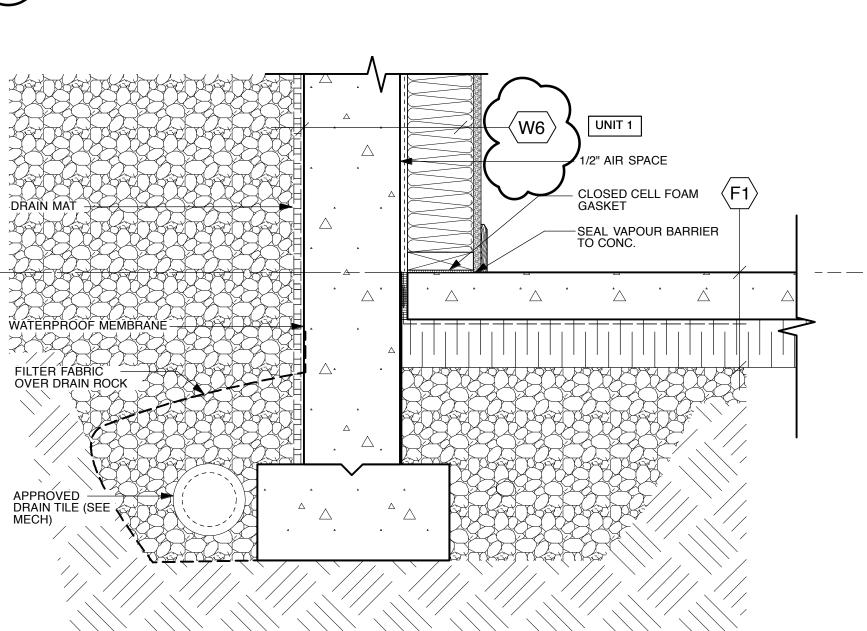

 $\begin{array}{c} 4 \\ A6.00 \end{array} \begin{array}{c} \text{SECTION DETAIL -FOUNDATION WALL} \\ \text{Scale: 1-1/2" = 1'-0"} \end{array}$

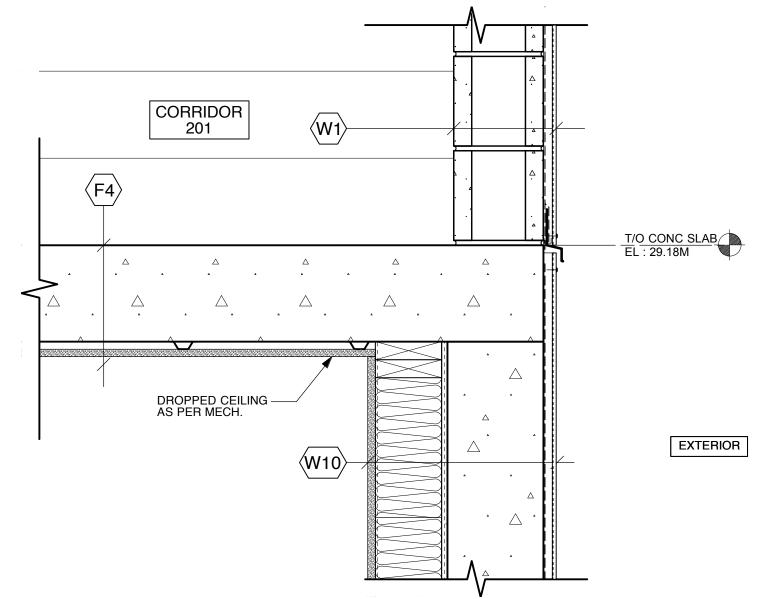



CONC. FONDATION WALL


UNIT 1

1/2" AIR SPACE -


WATERPROOF MEMBRANE

DRAIN MAT




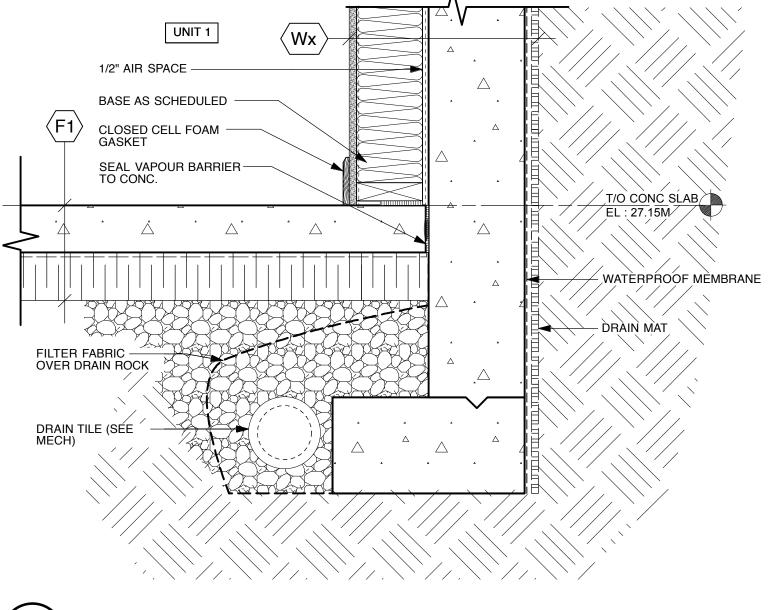


SECTION DETAIL -FOUNDATION WALL Scale: 1-1/2" = 1'-0" A6.00

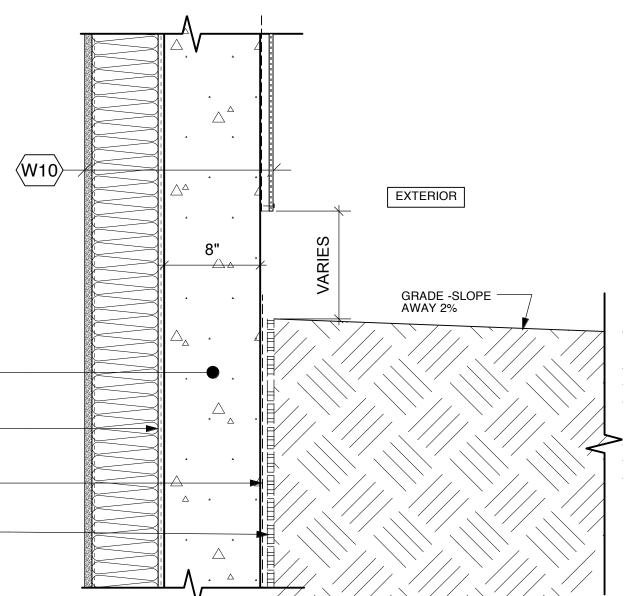


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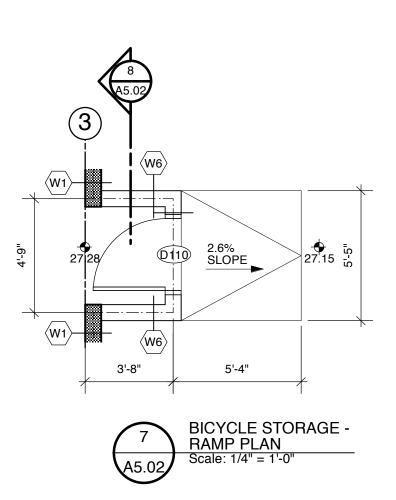


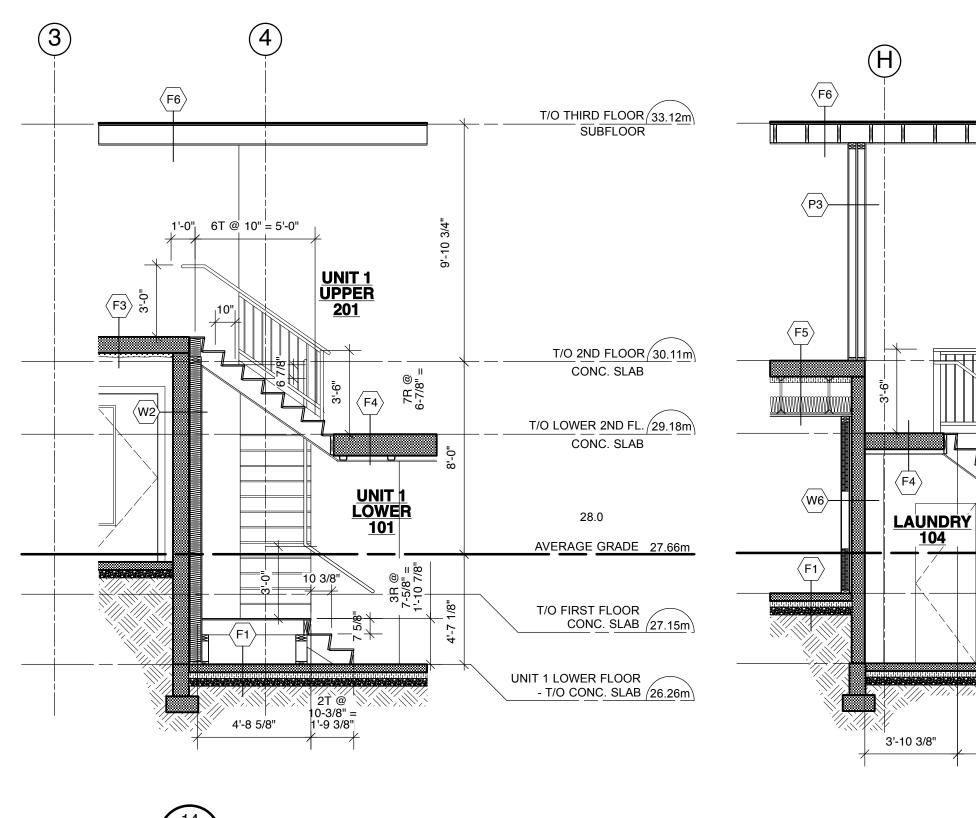


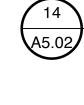
UNIT 1 - STAIR 1 SECTION 2 Scale: 1/4" = 1'-0"




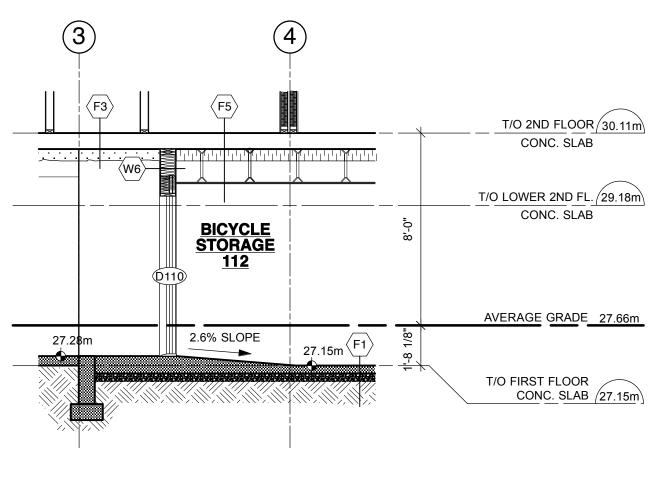





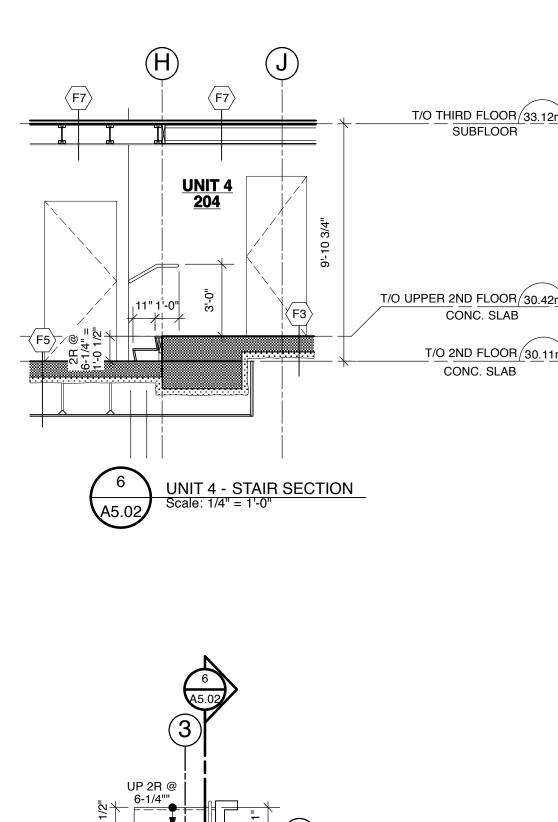


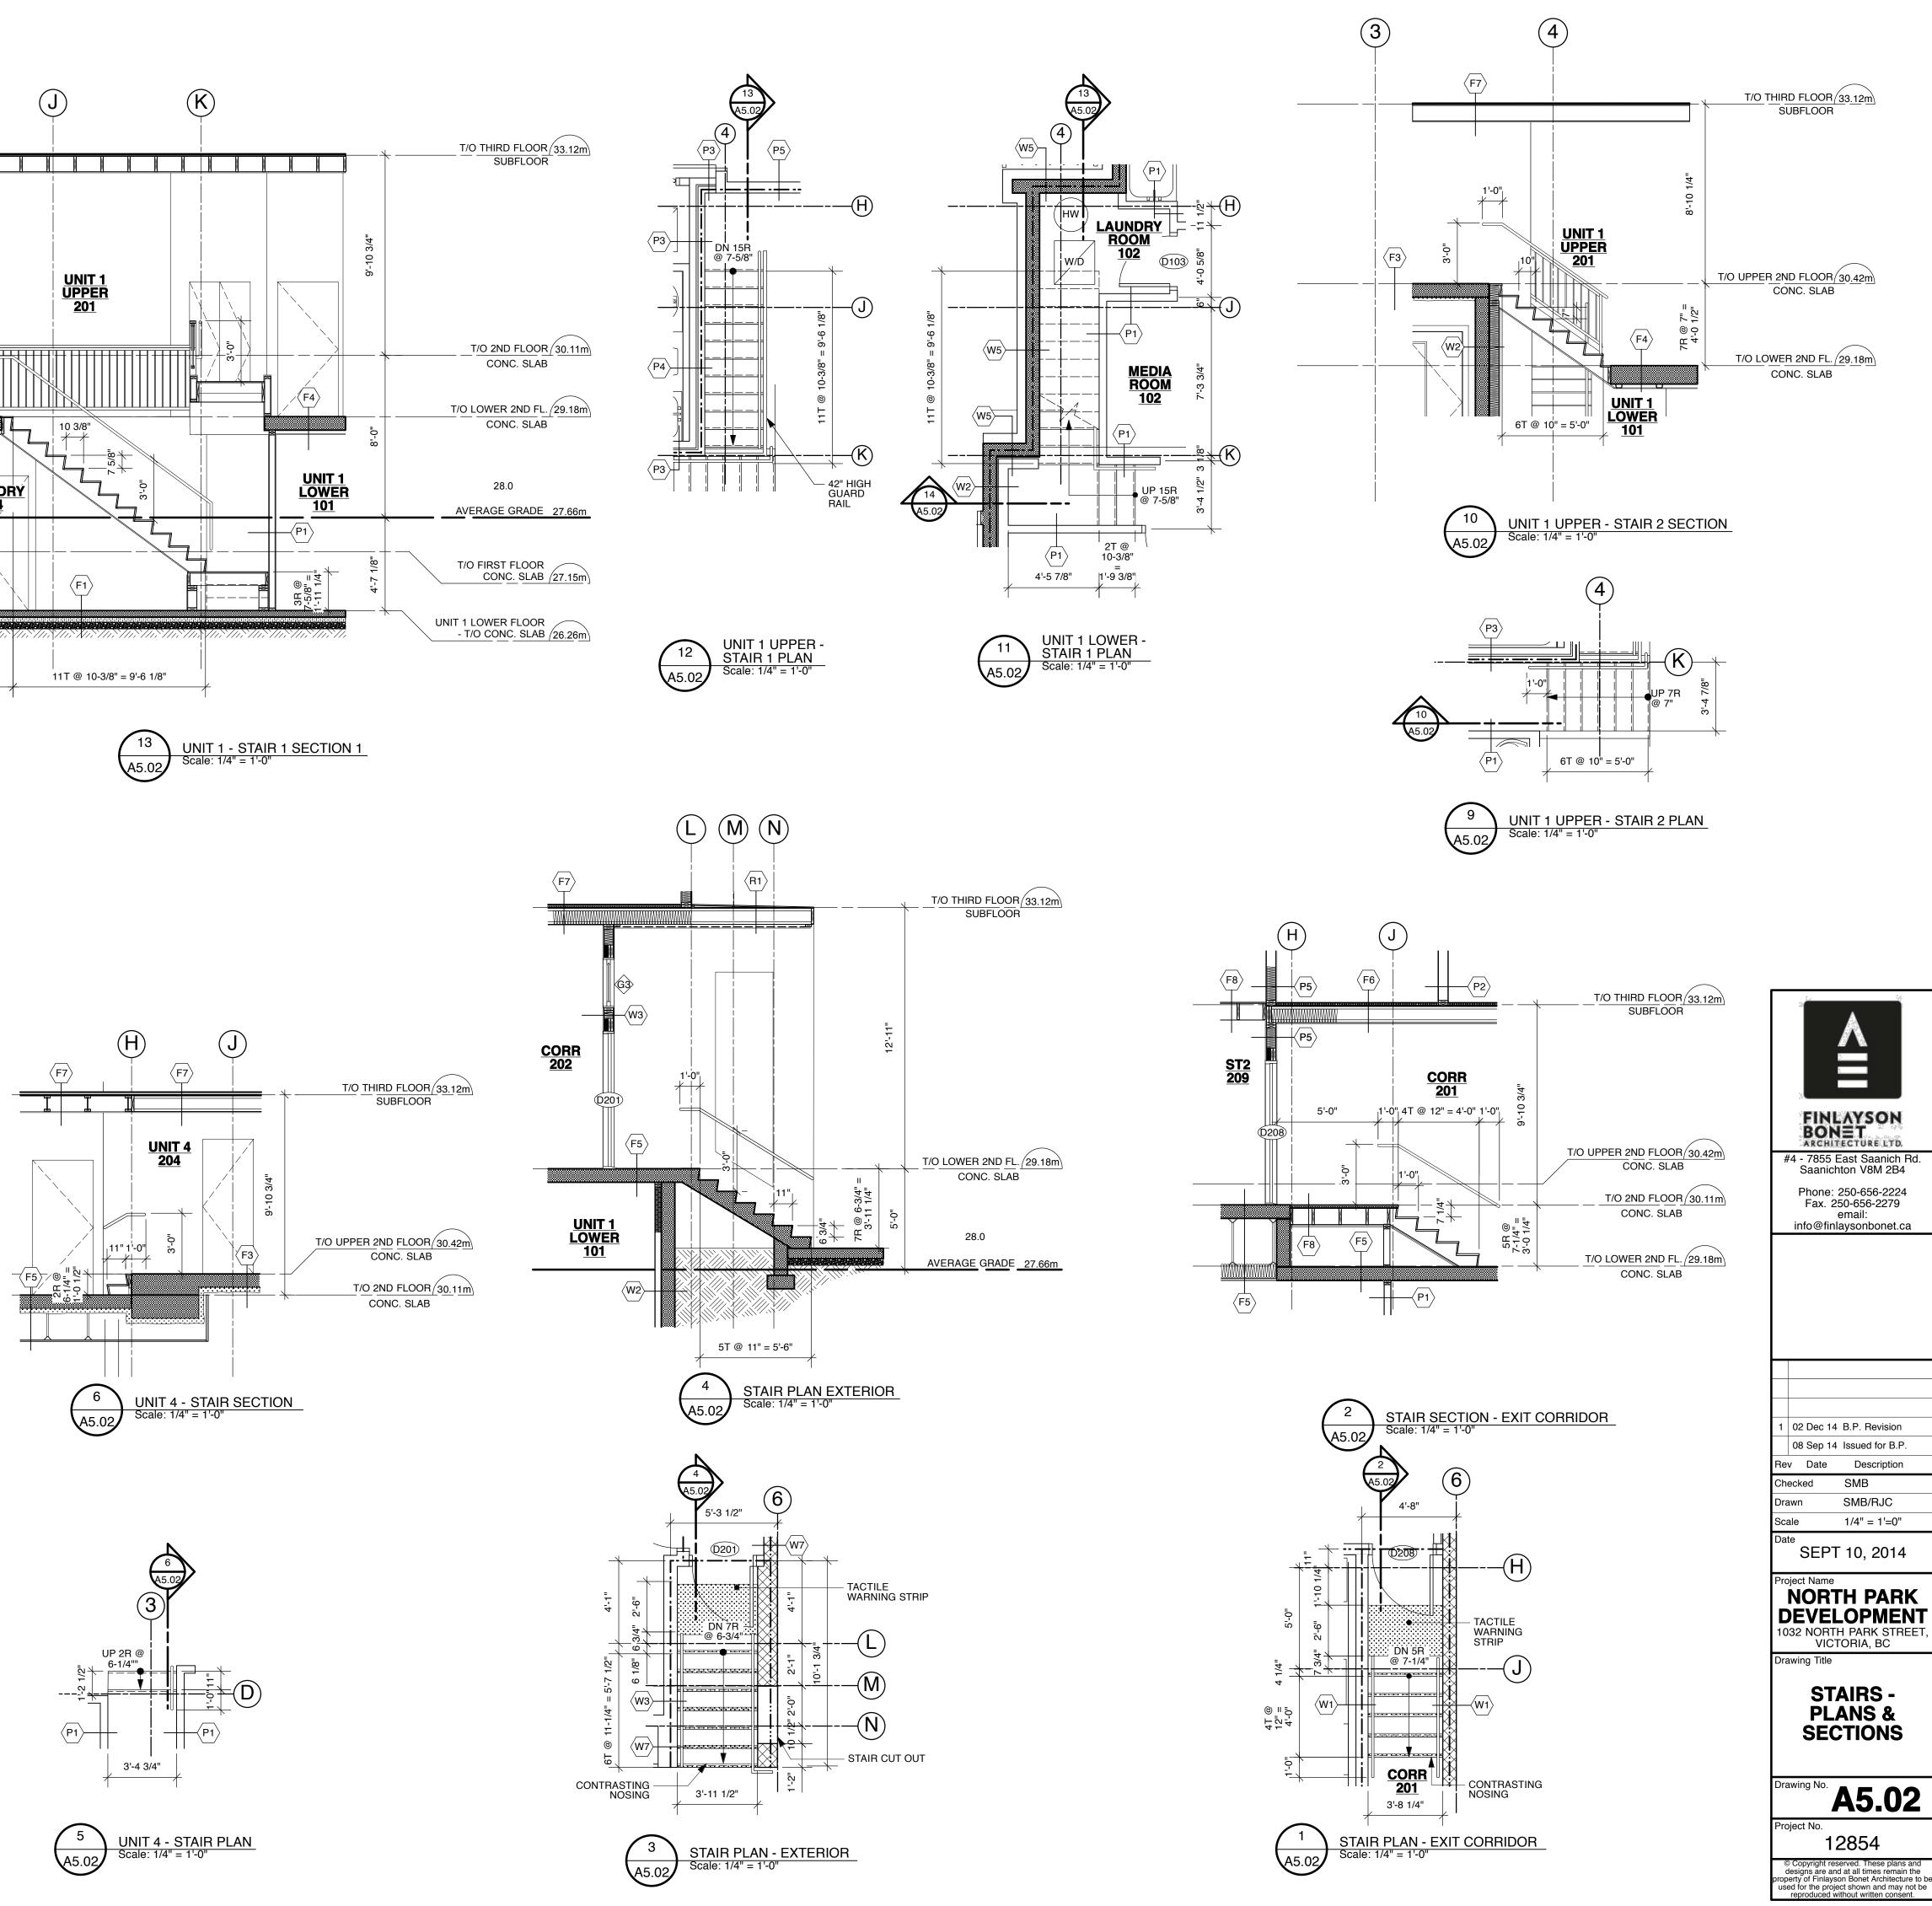

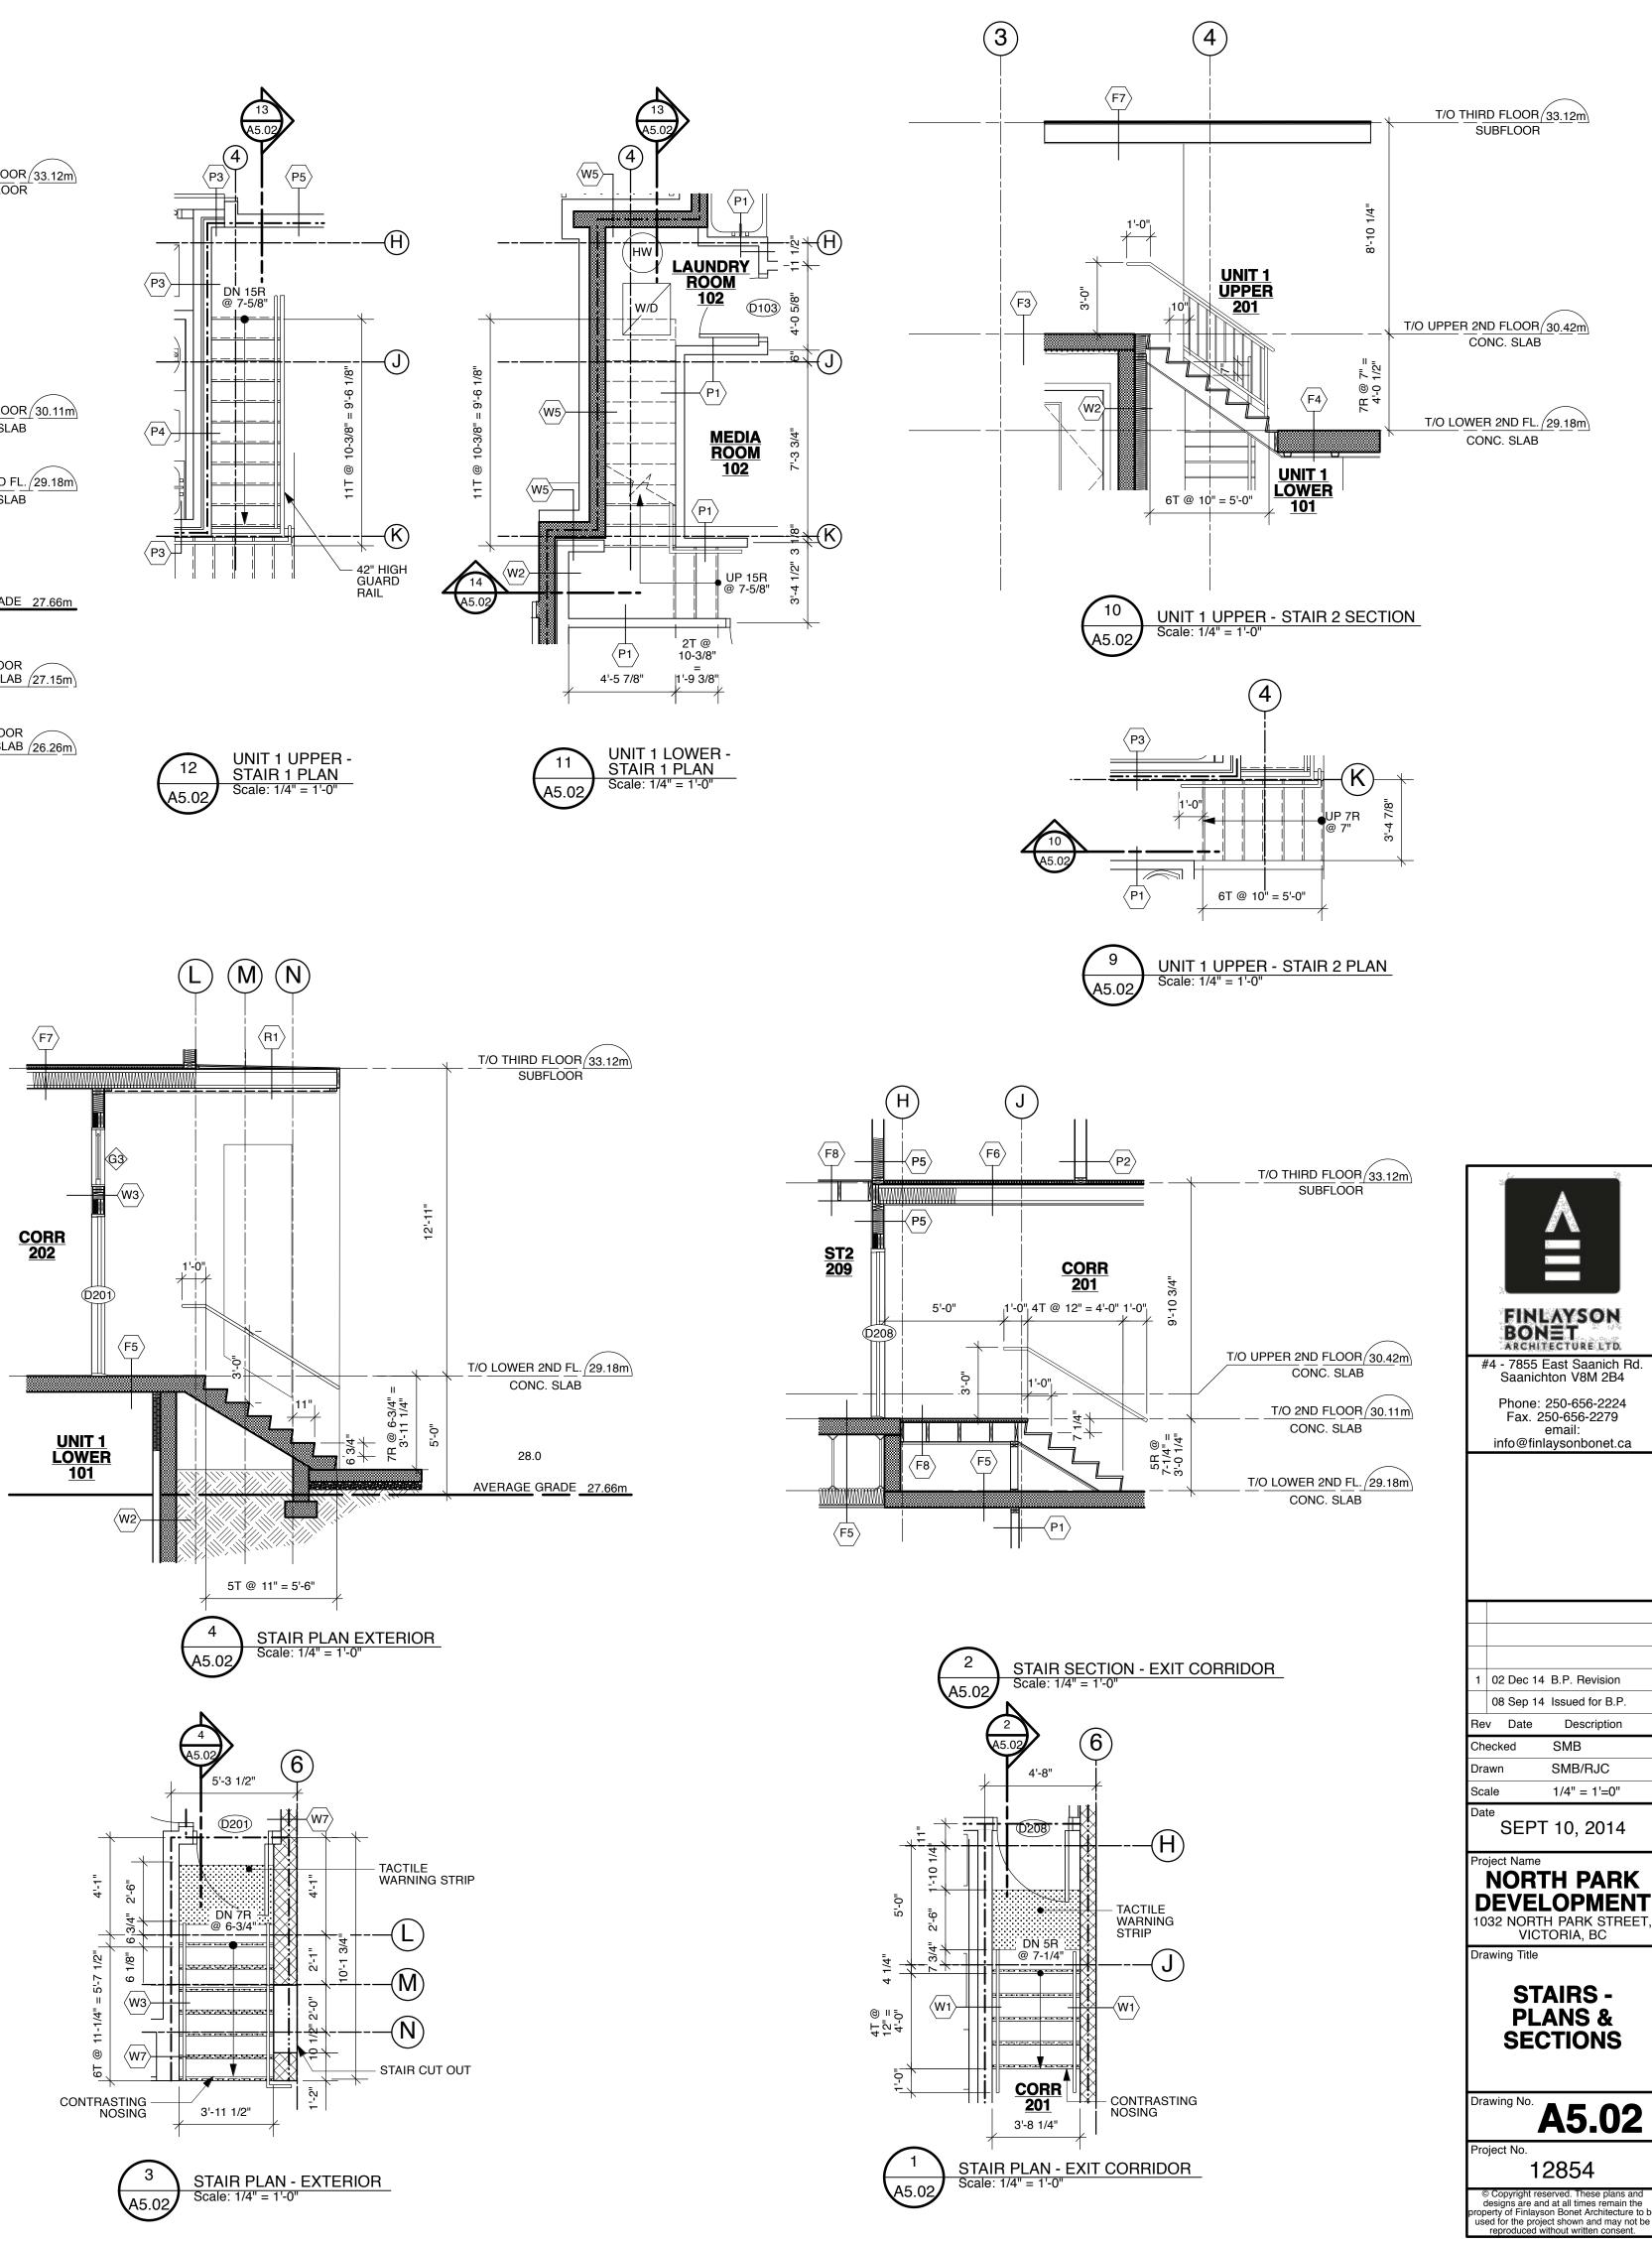


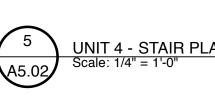


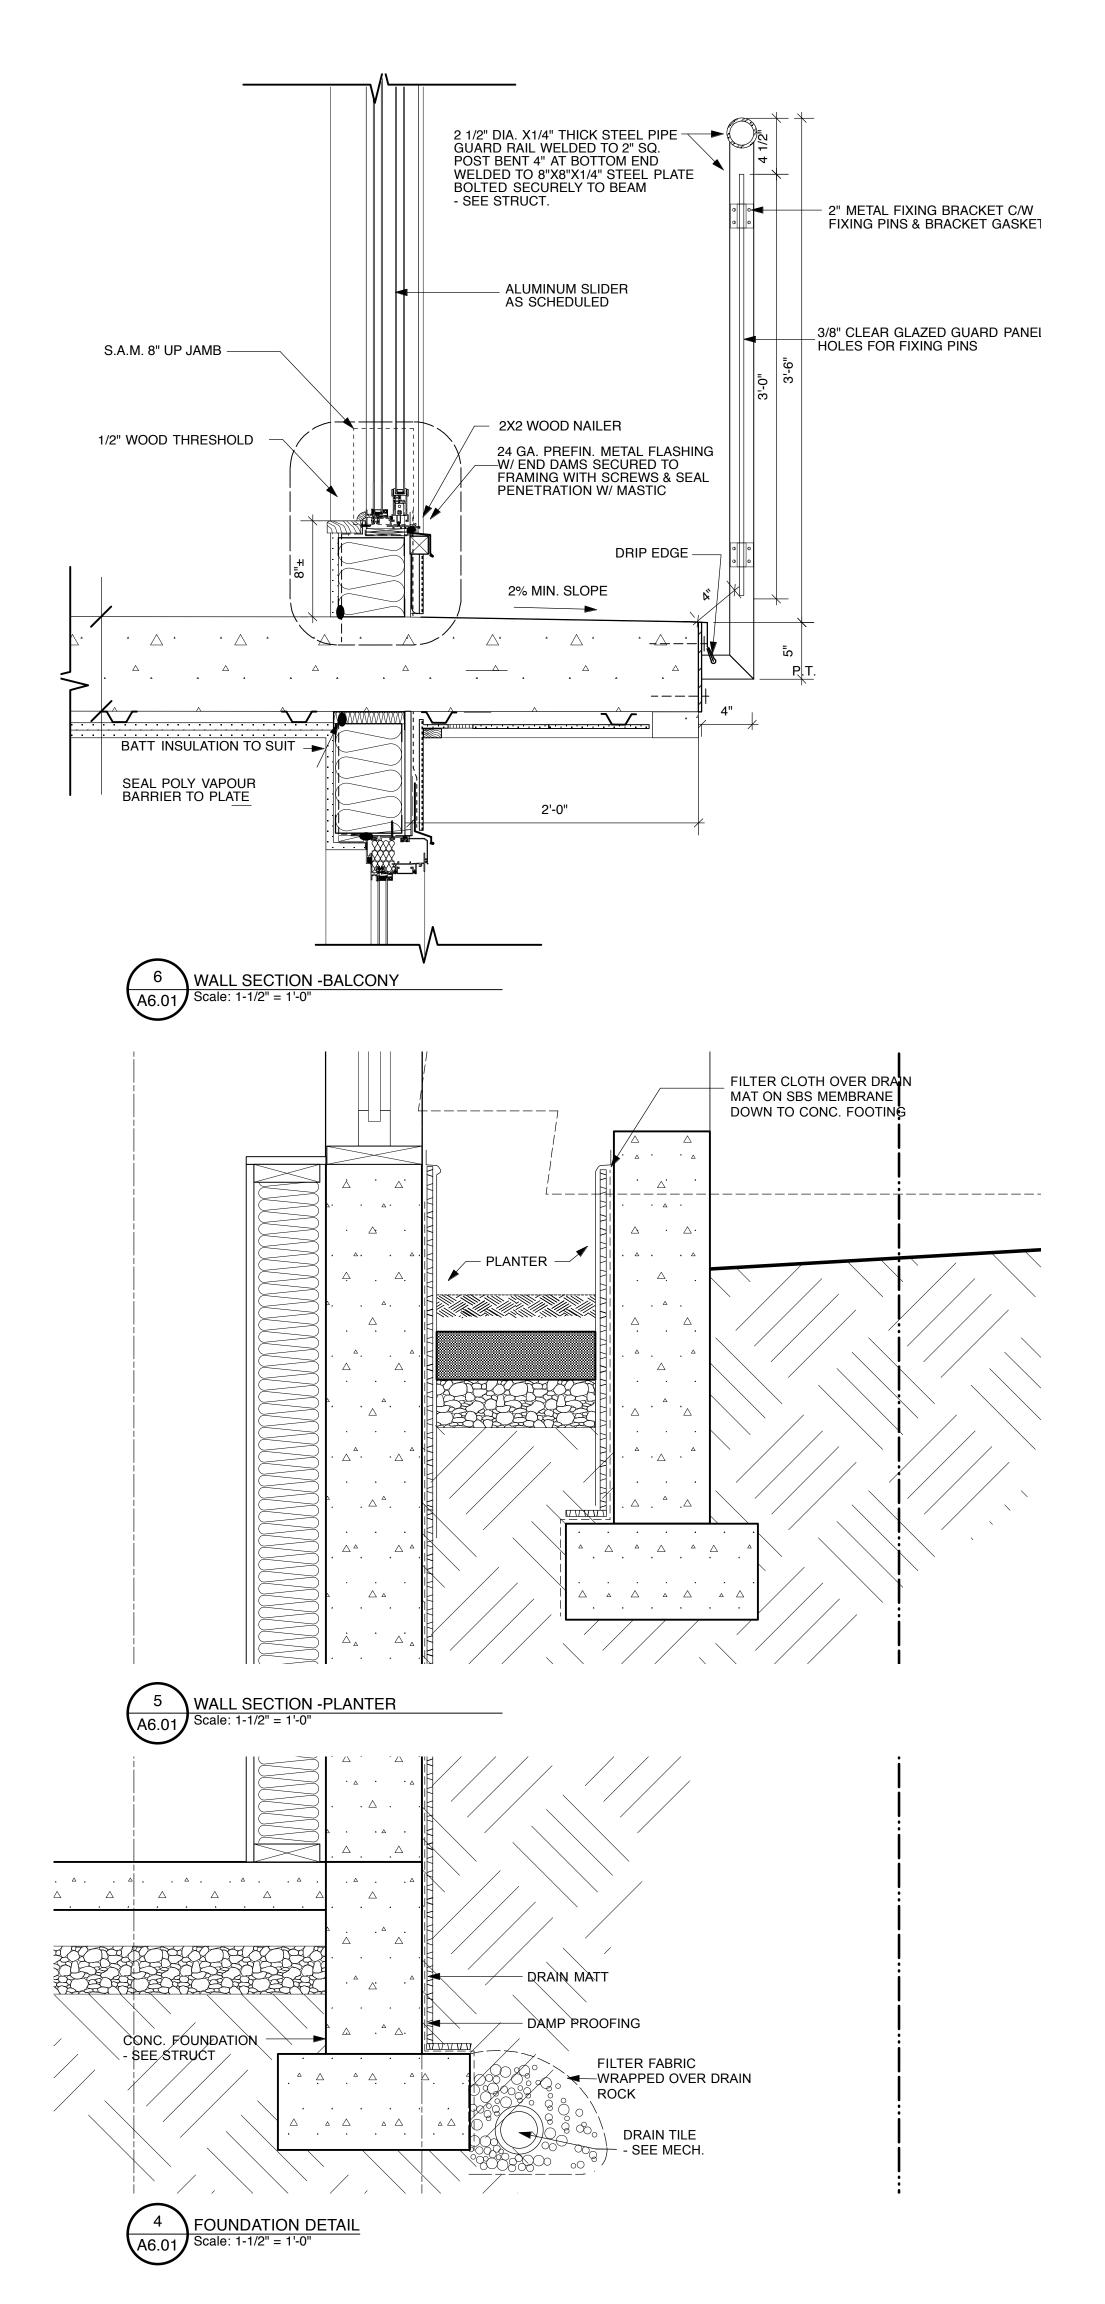


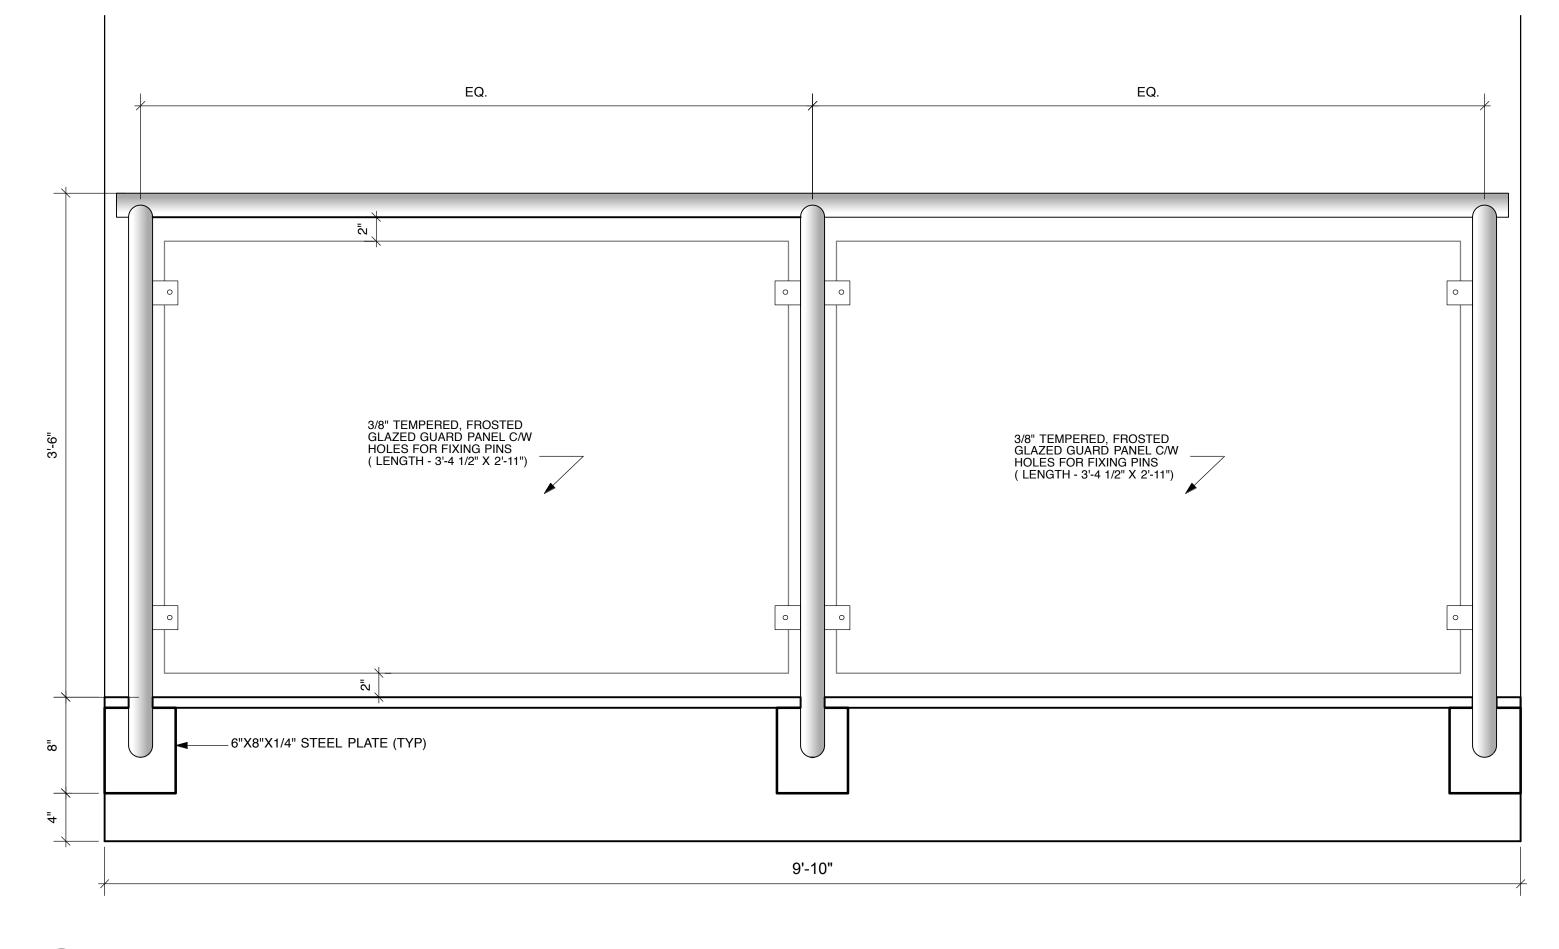



3 DETAIL -BALCONY RAILING A6.01 Scale: 1-1/2" = 1'-0"

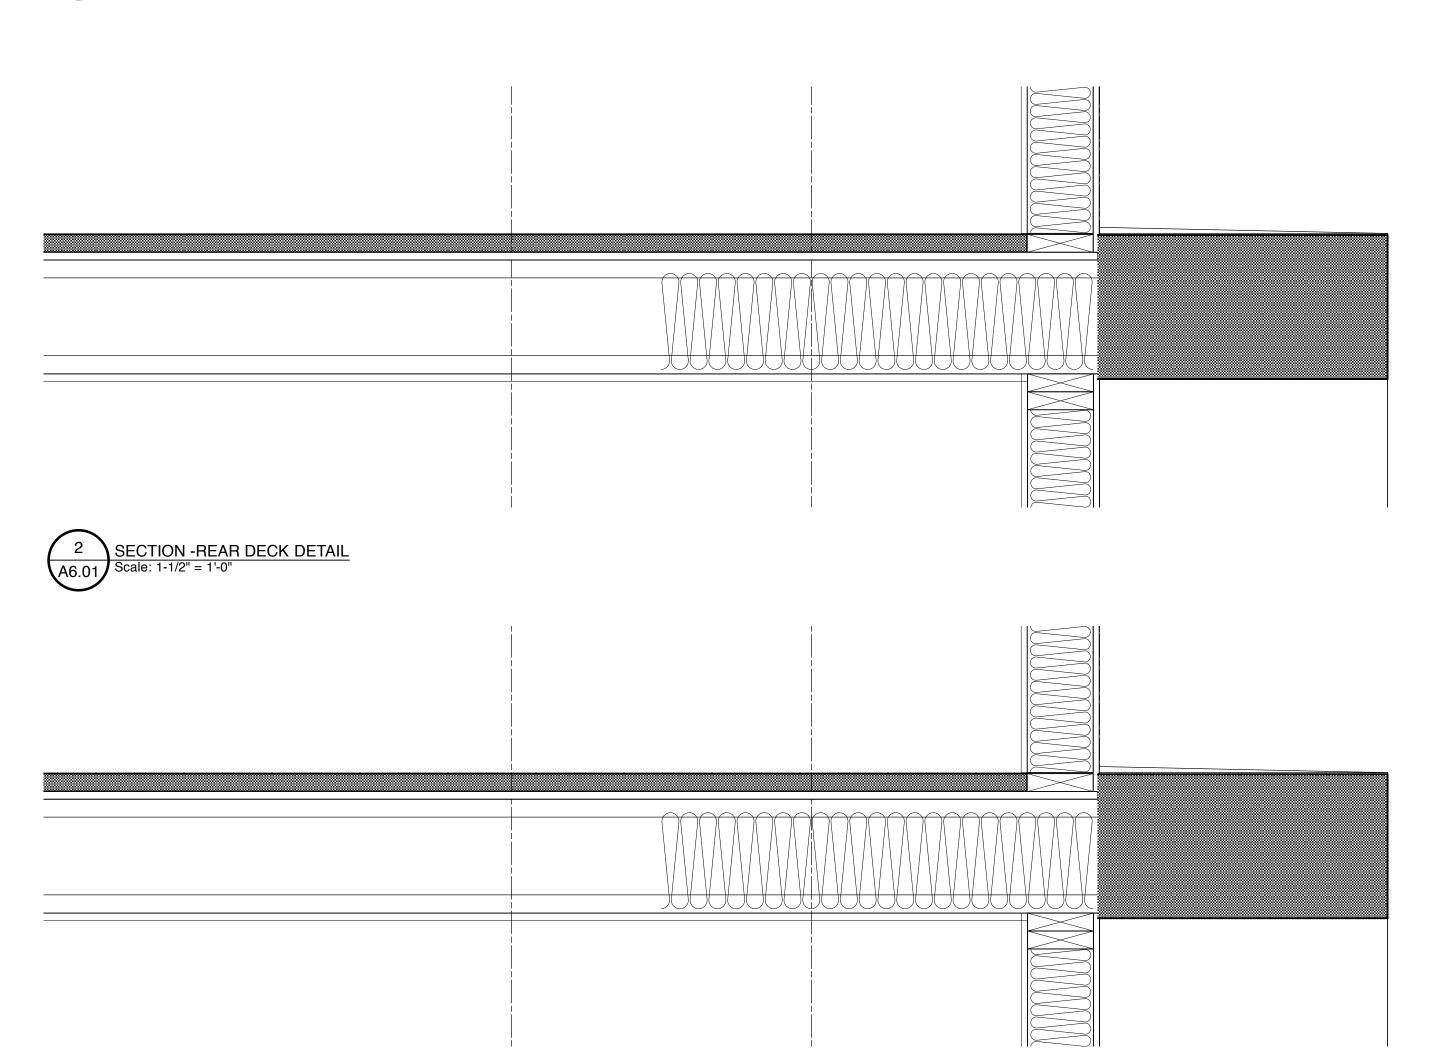


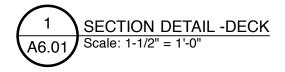


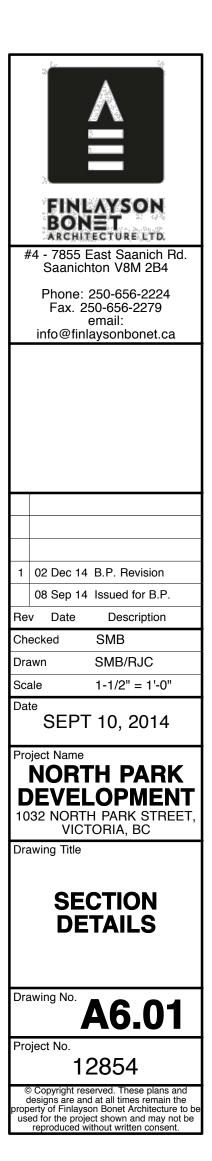

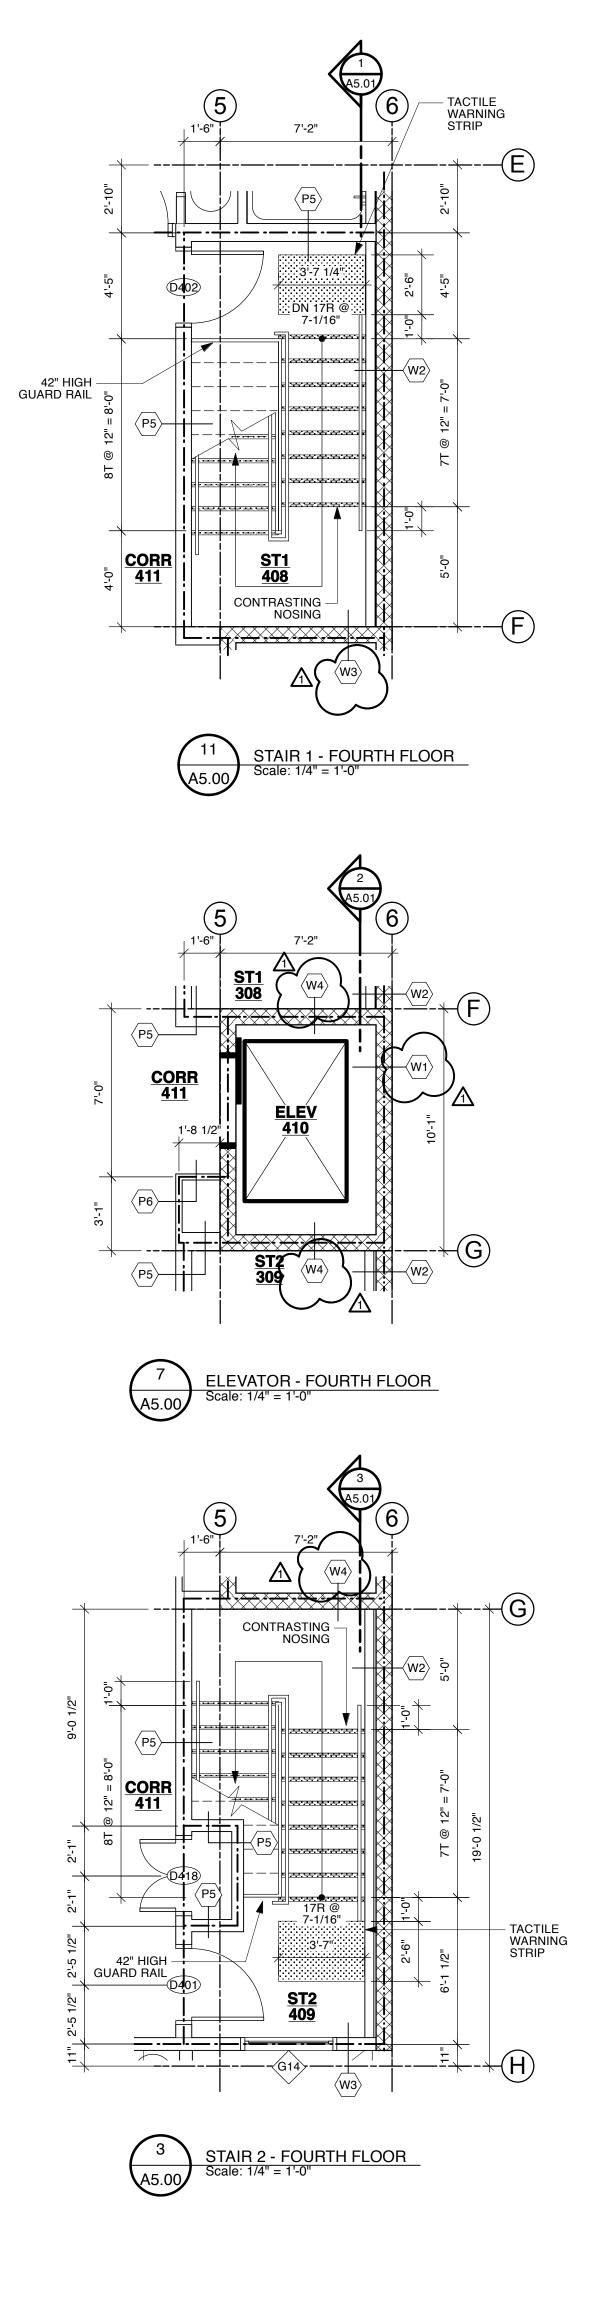

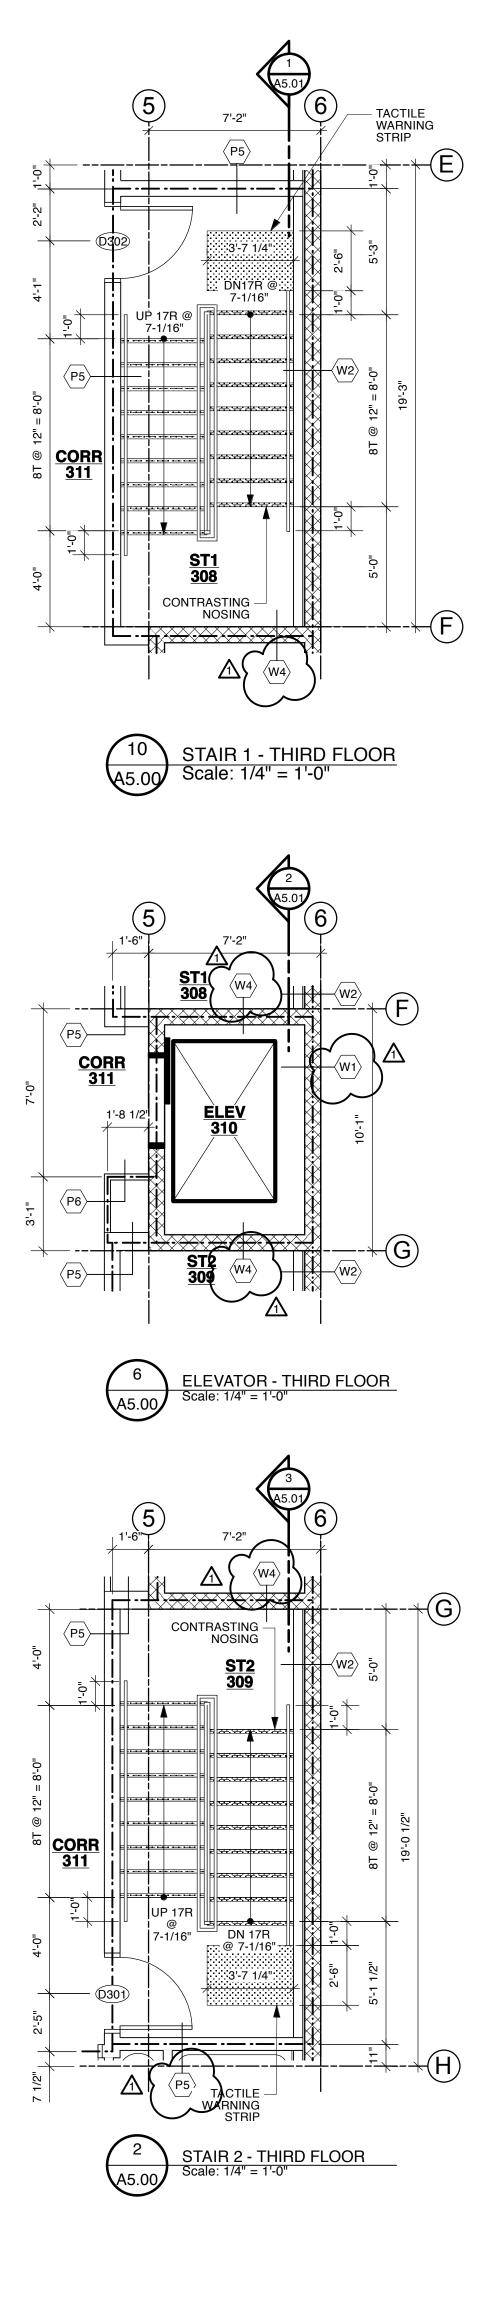

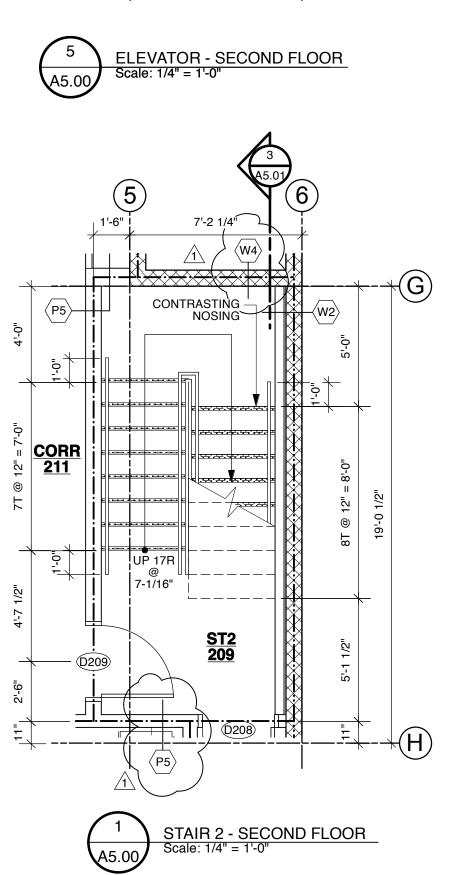

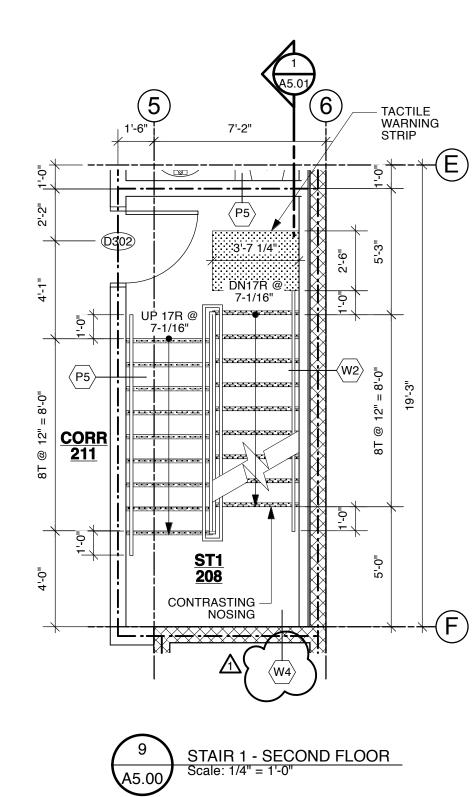



5 7'-2" /1 $\langle W4$ P5 <u>CORR</u> 211 <u>ÈLÉV</u> <u>210</u> 1'-8 1/2" -G

<u>ST2</u> (W4)

-{w2>

(P5)

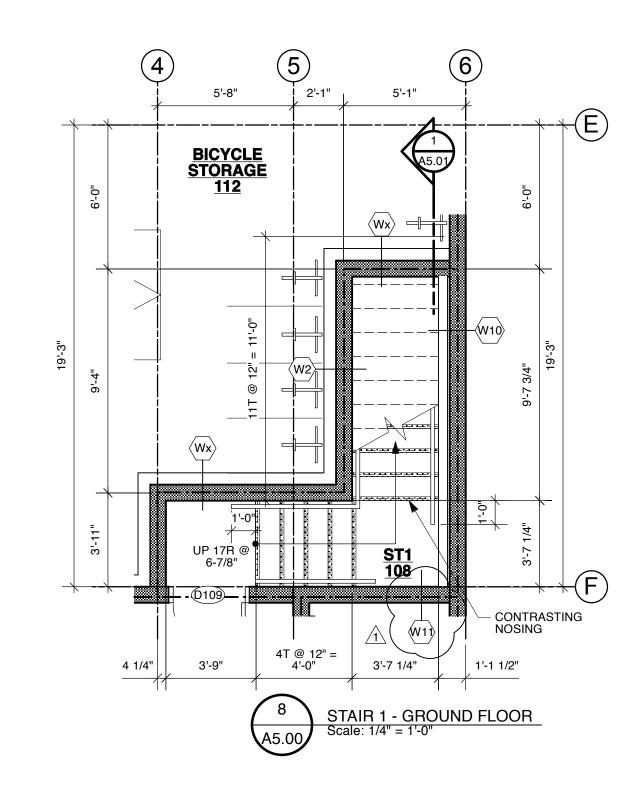


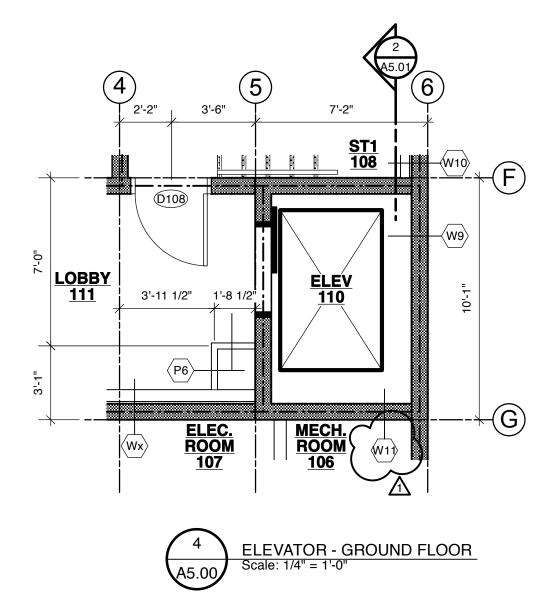



WALL RATING LEGEND:


1.5 HR F.R.R. PARTITION WALL -----

2.0 HR F.R.R. PARTITION WALL _____

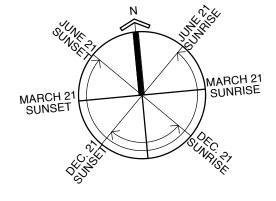


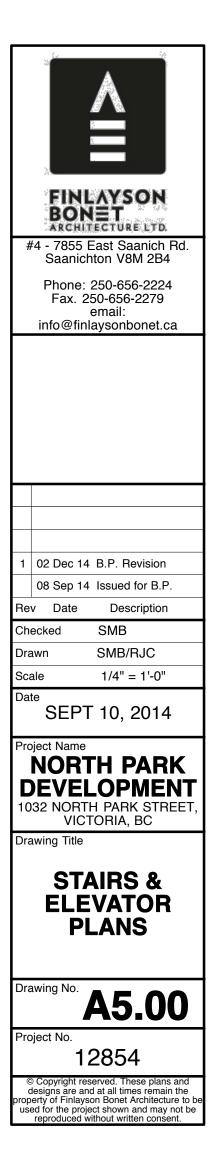


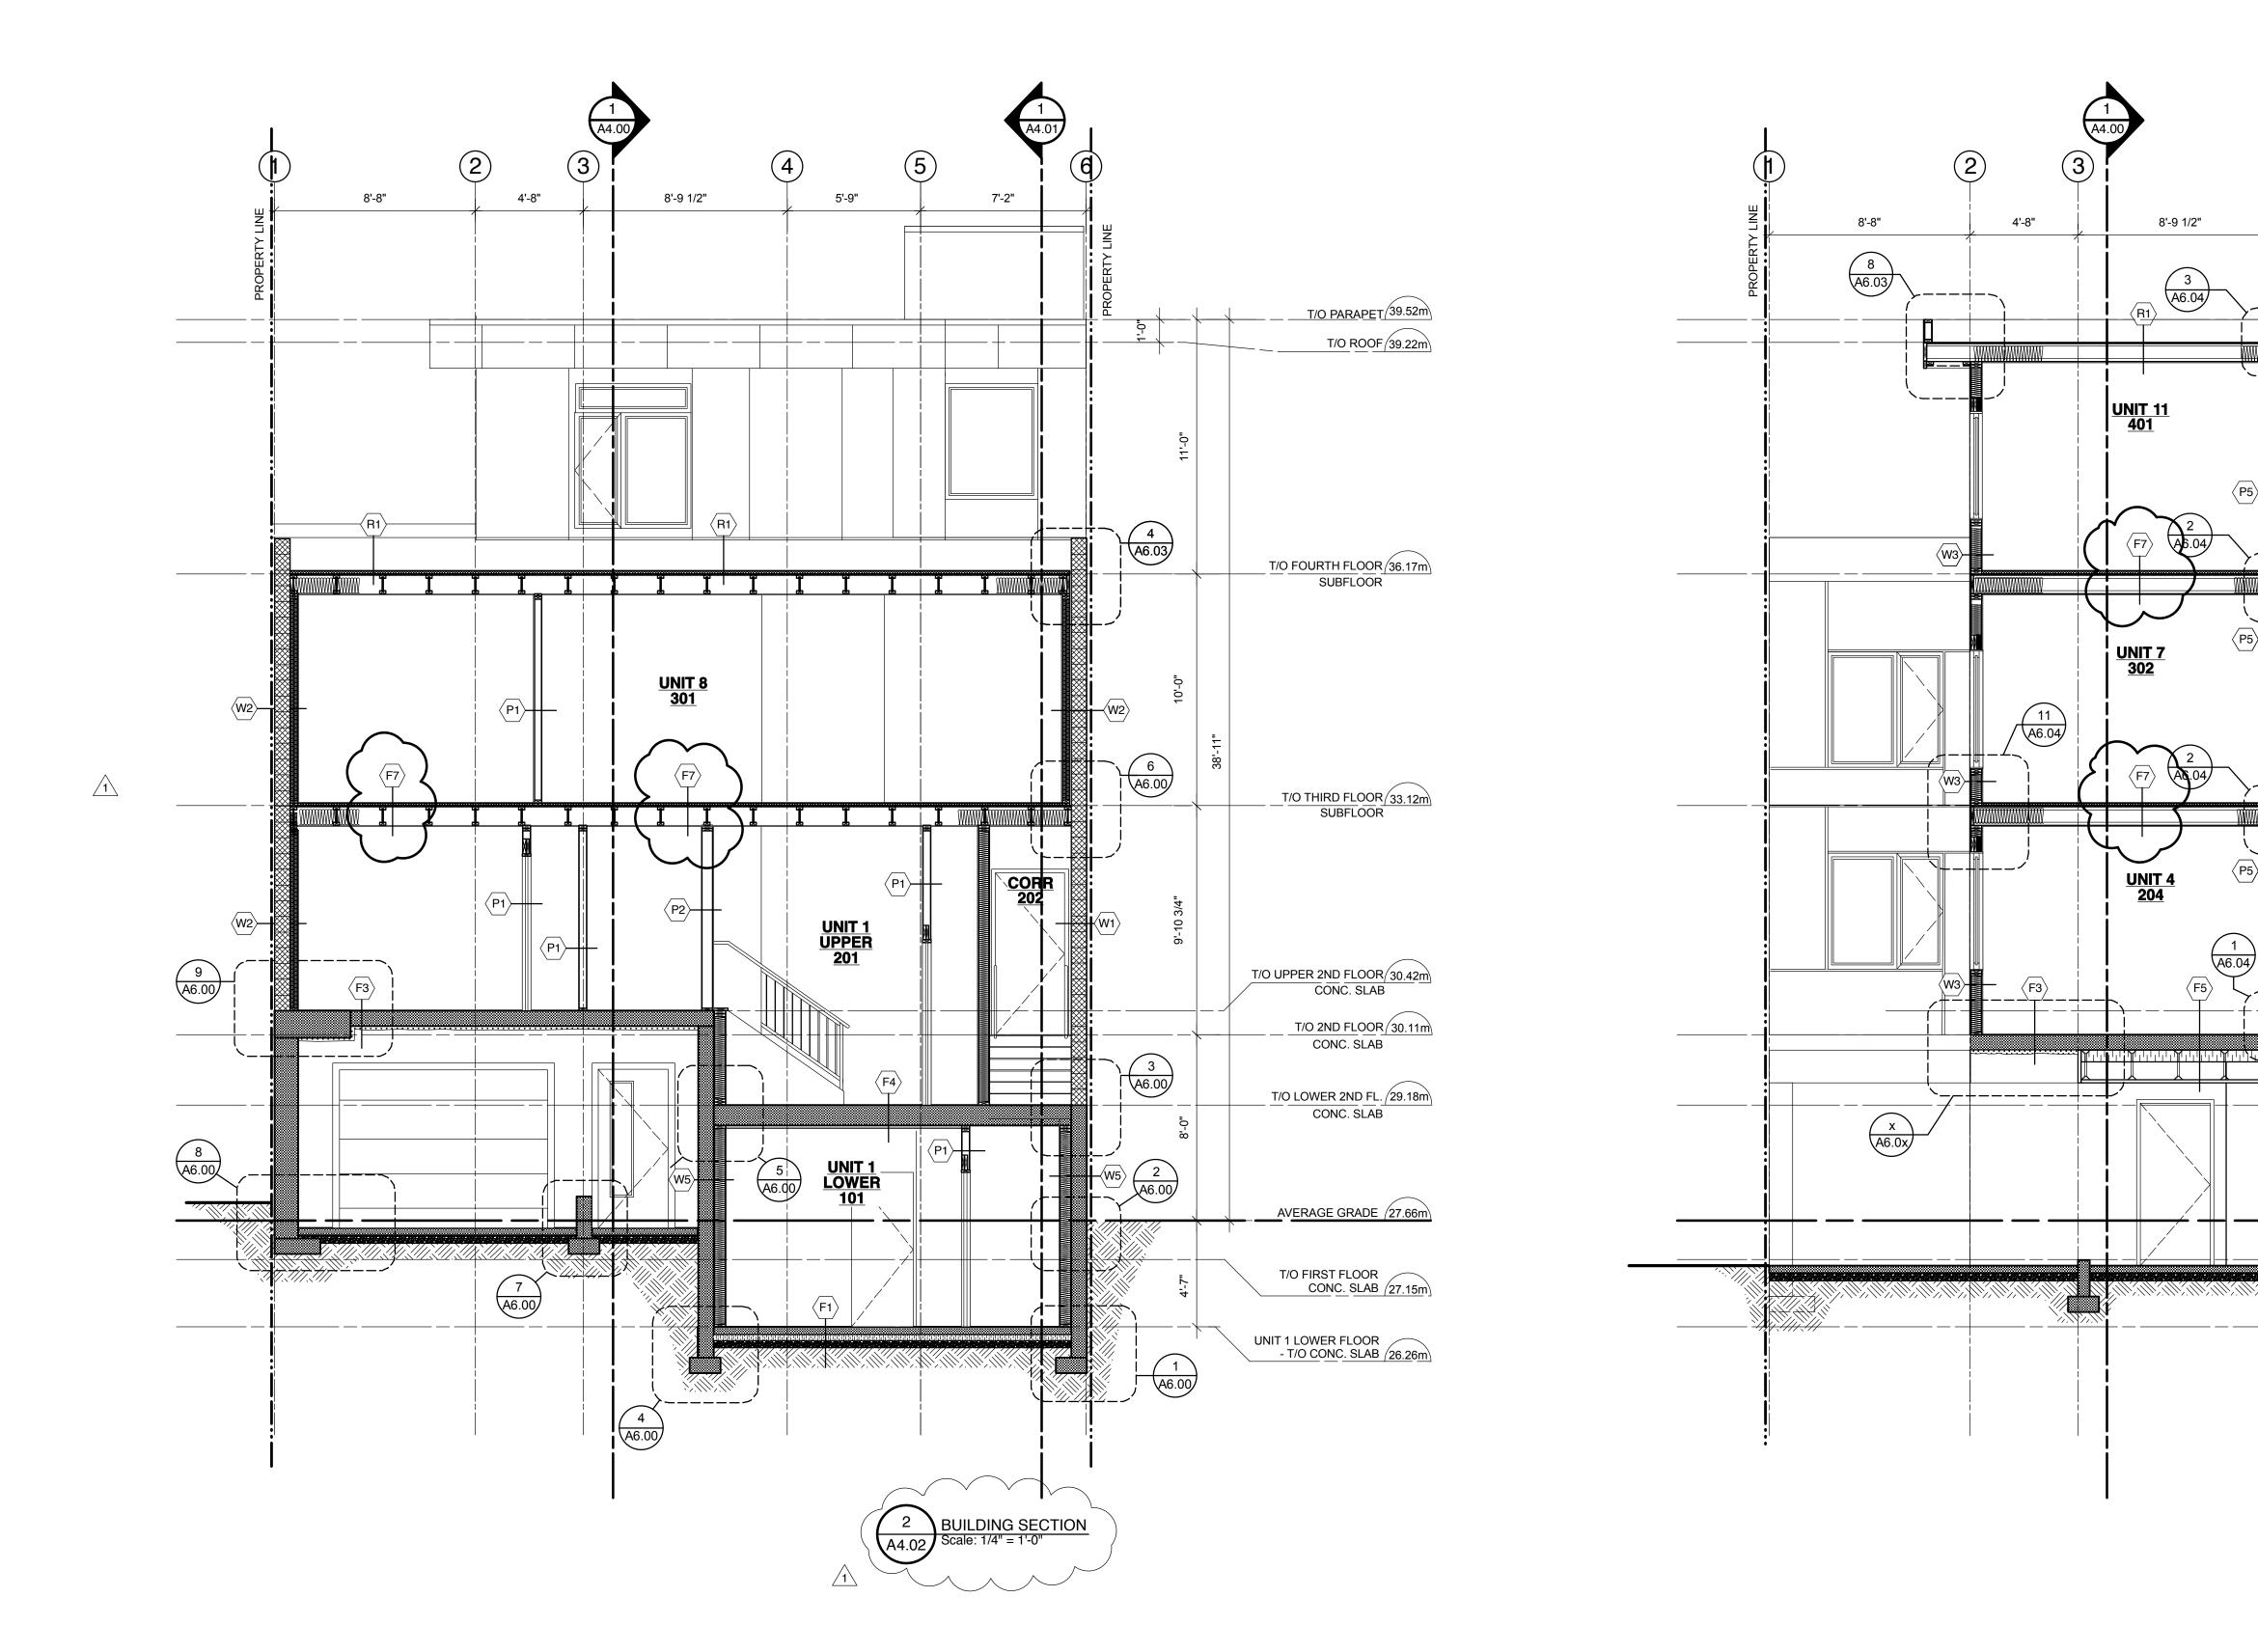

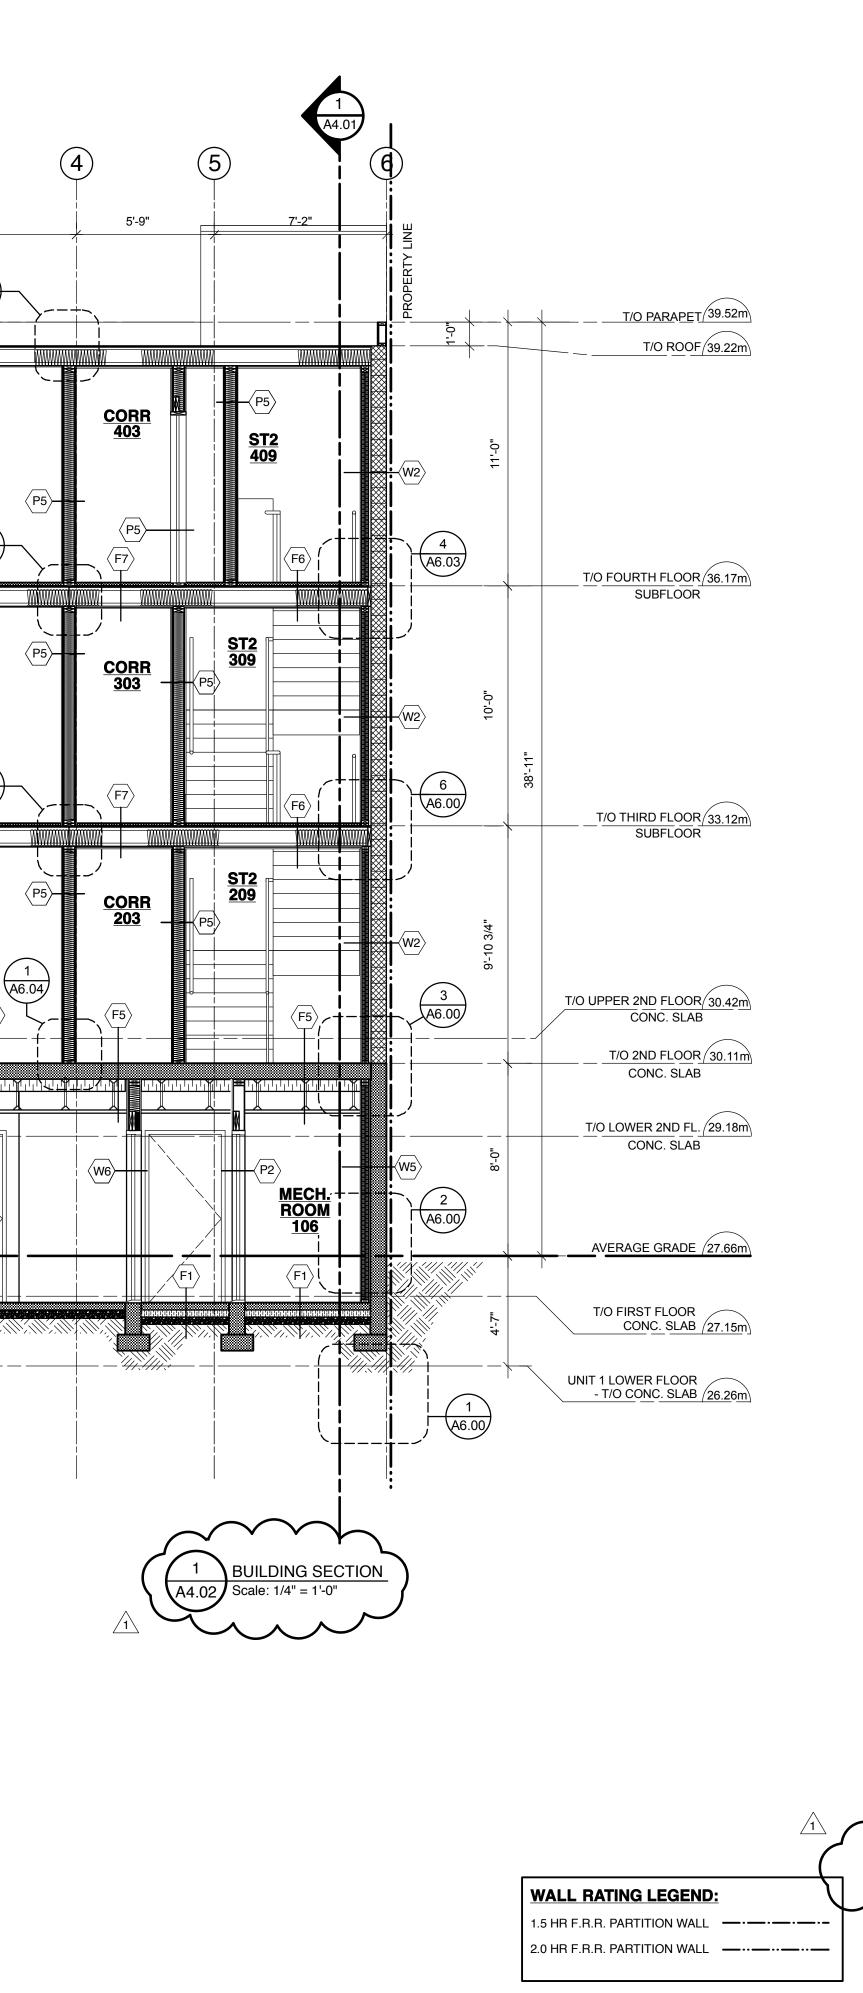



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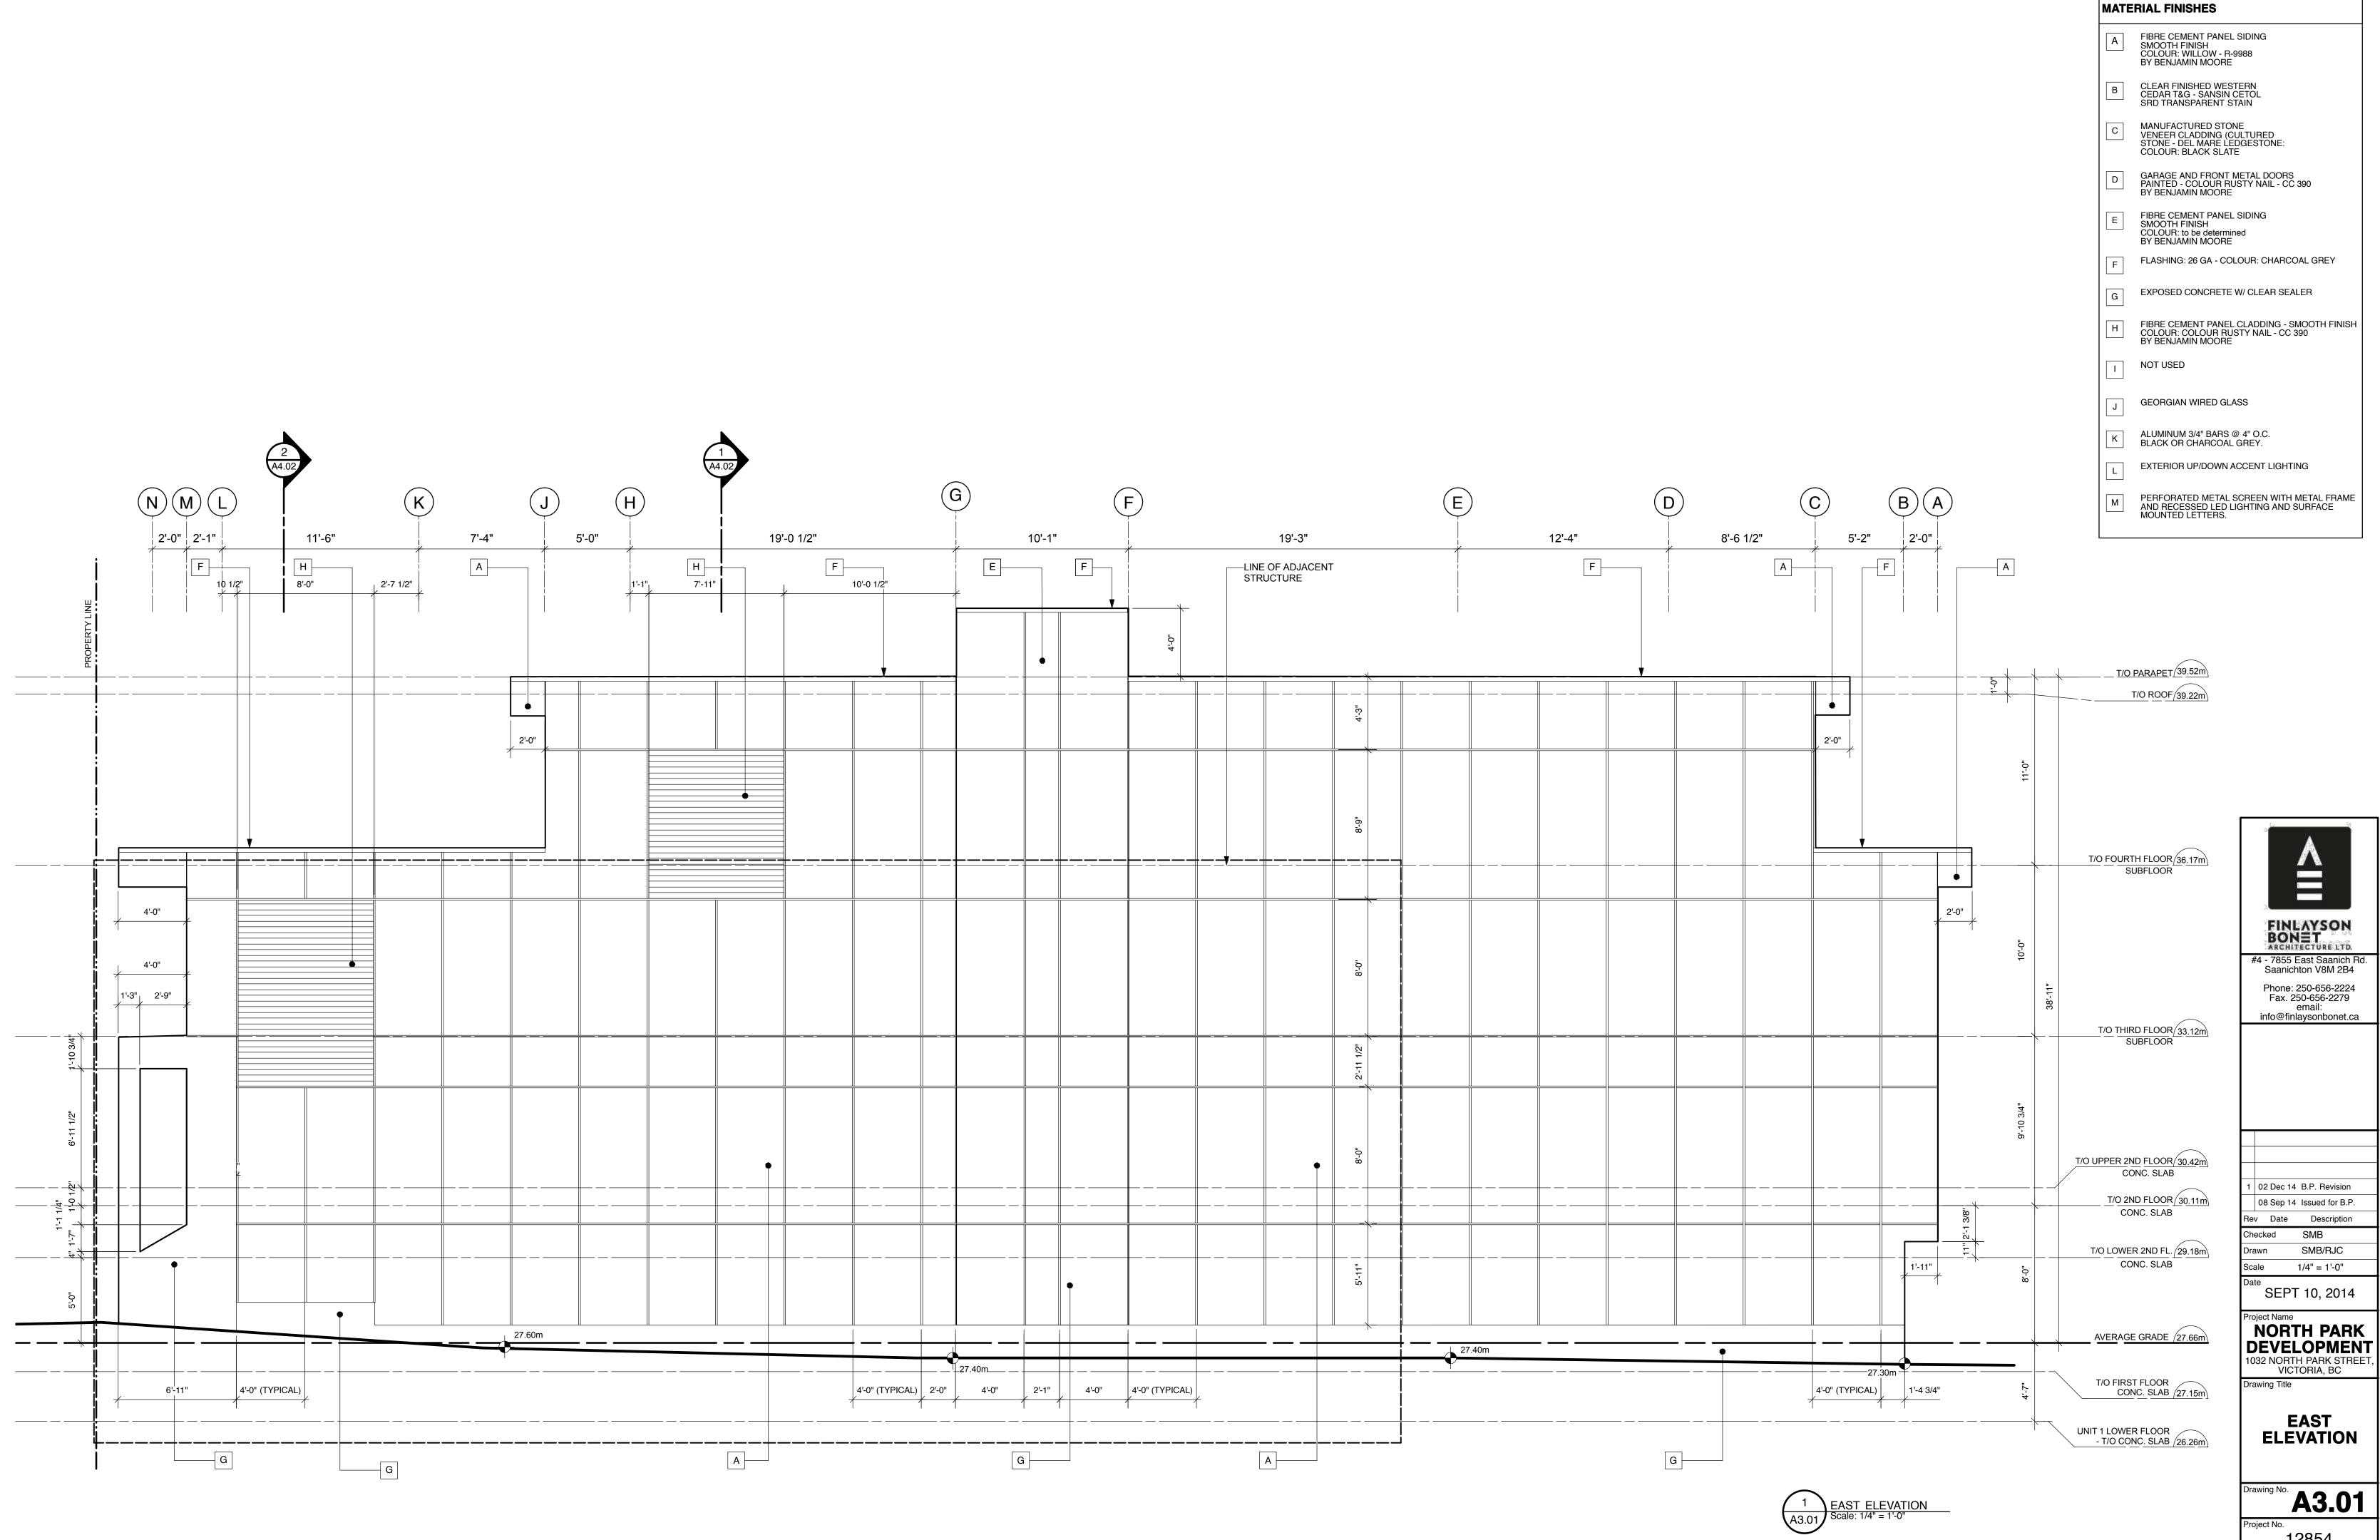

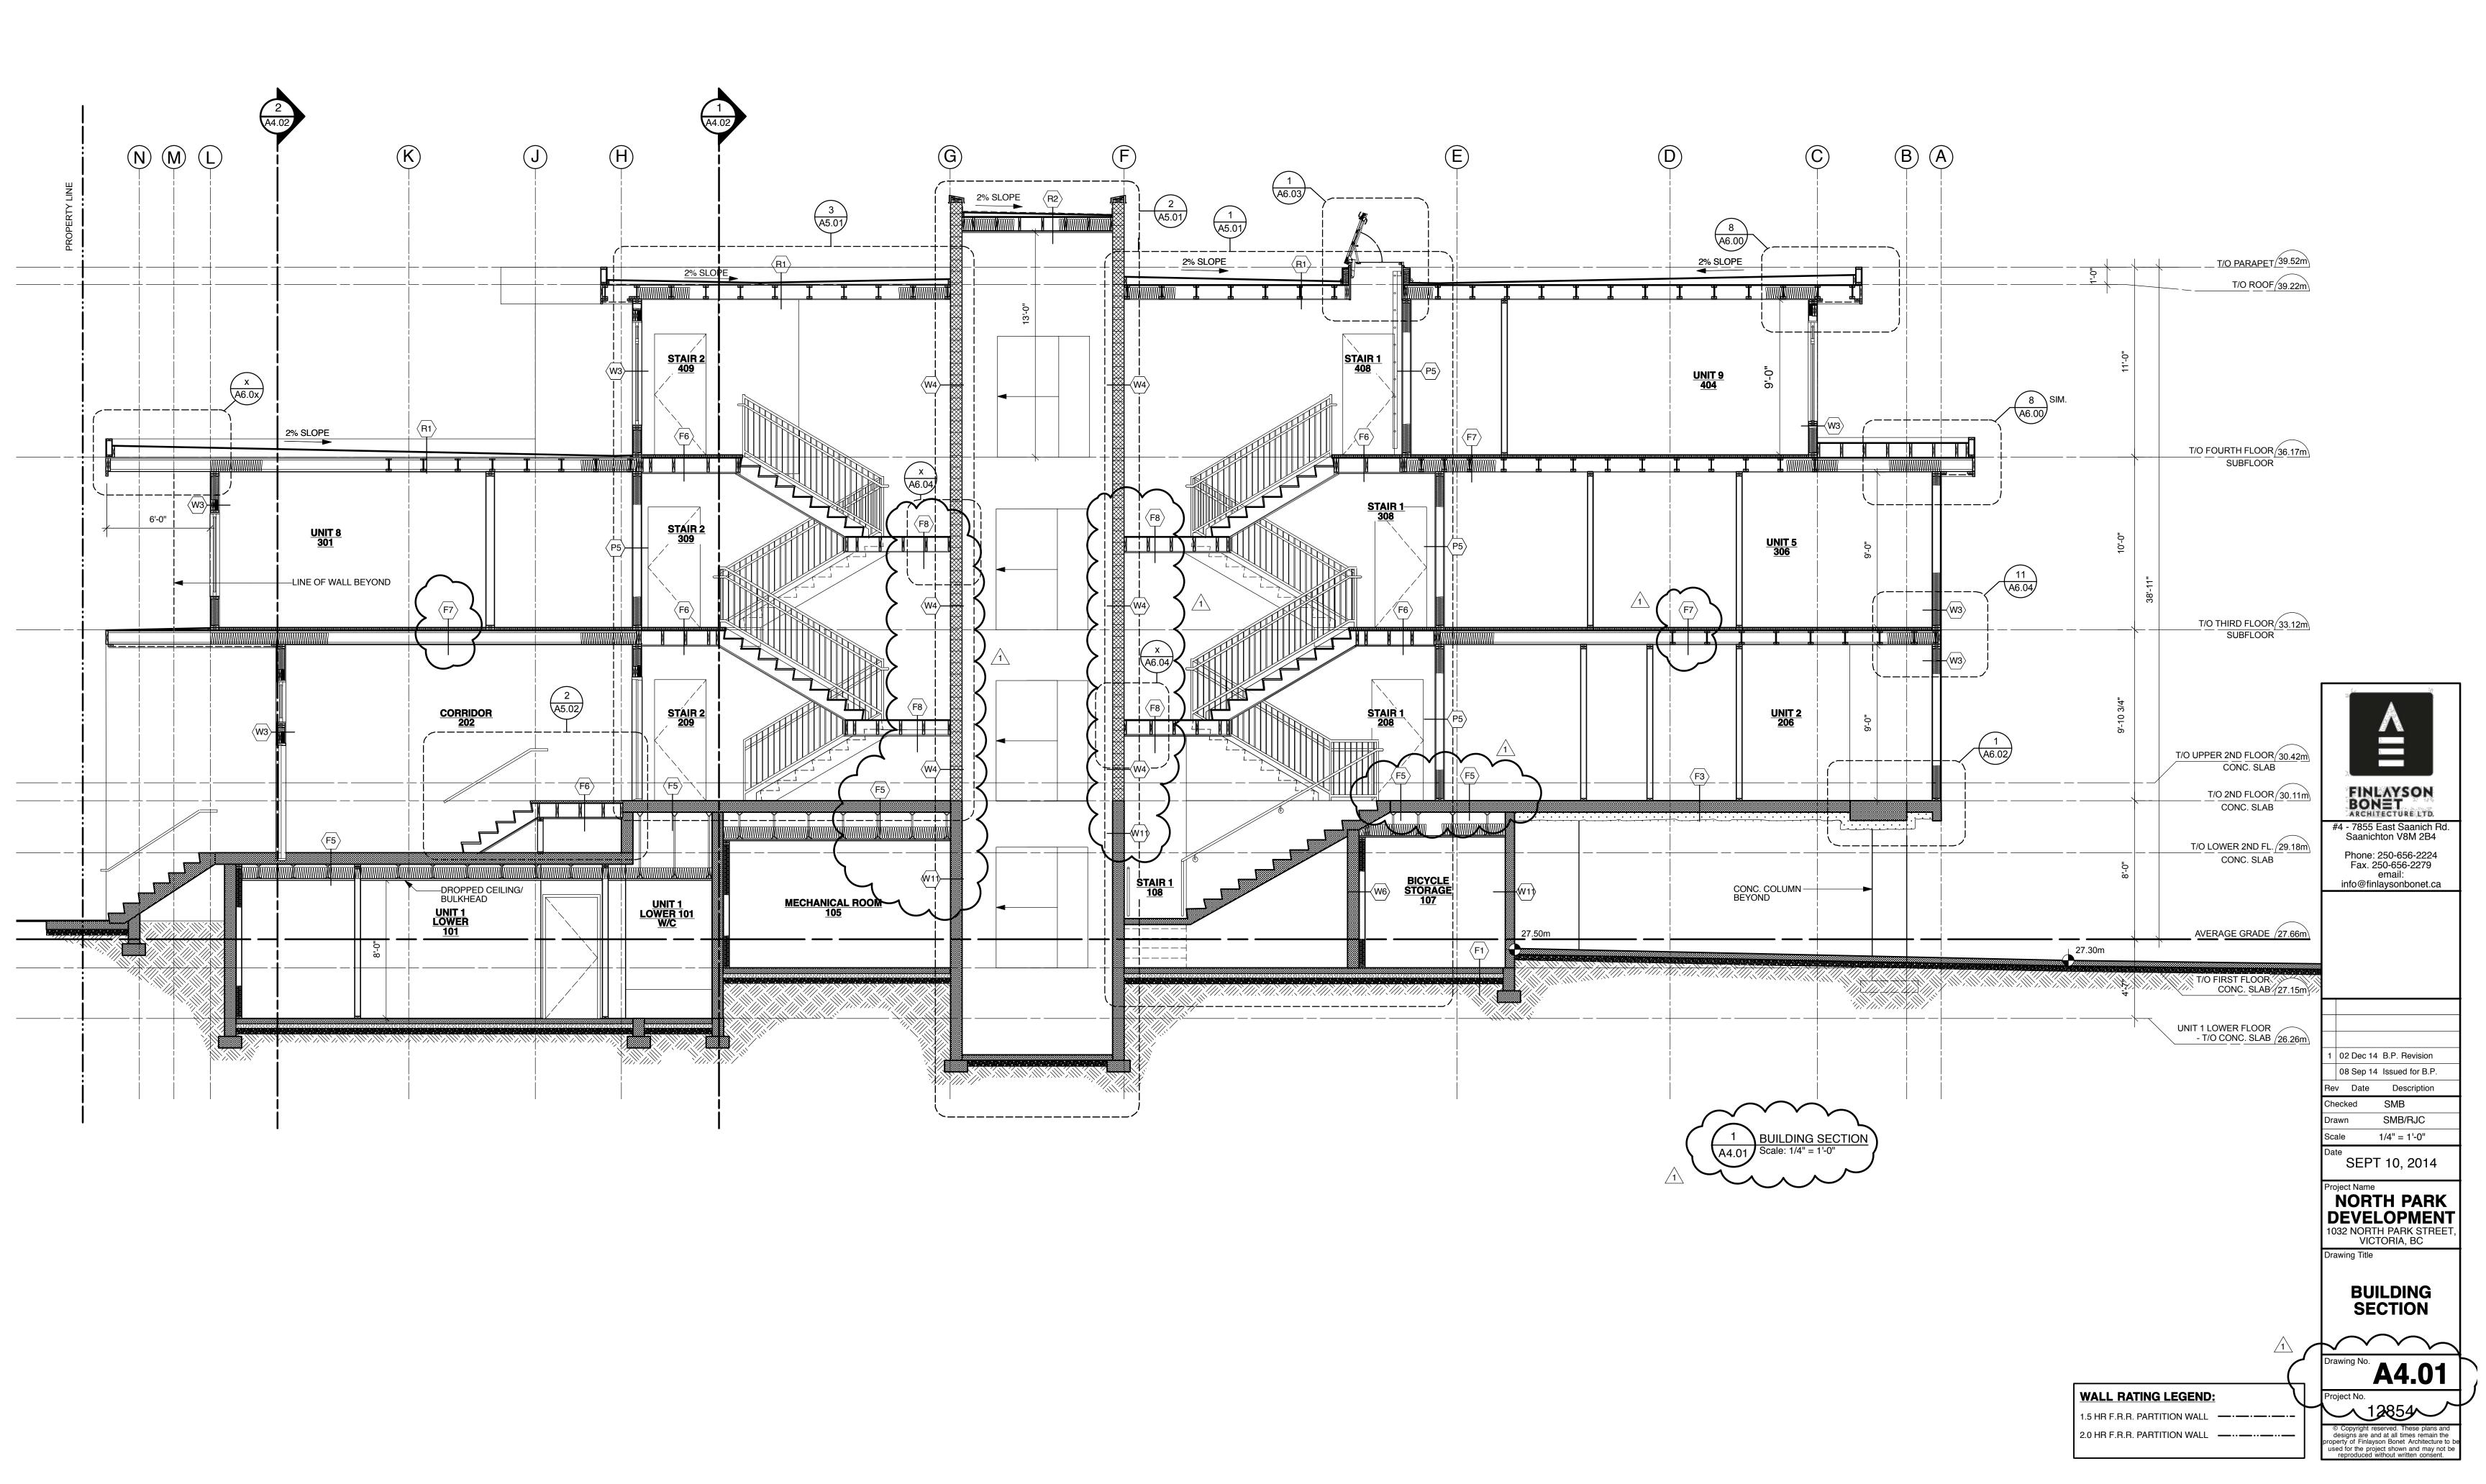
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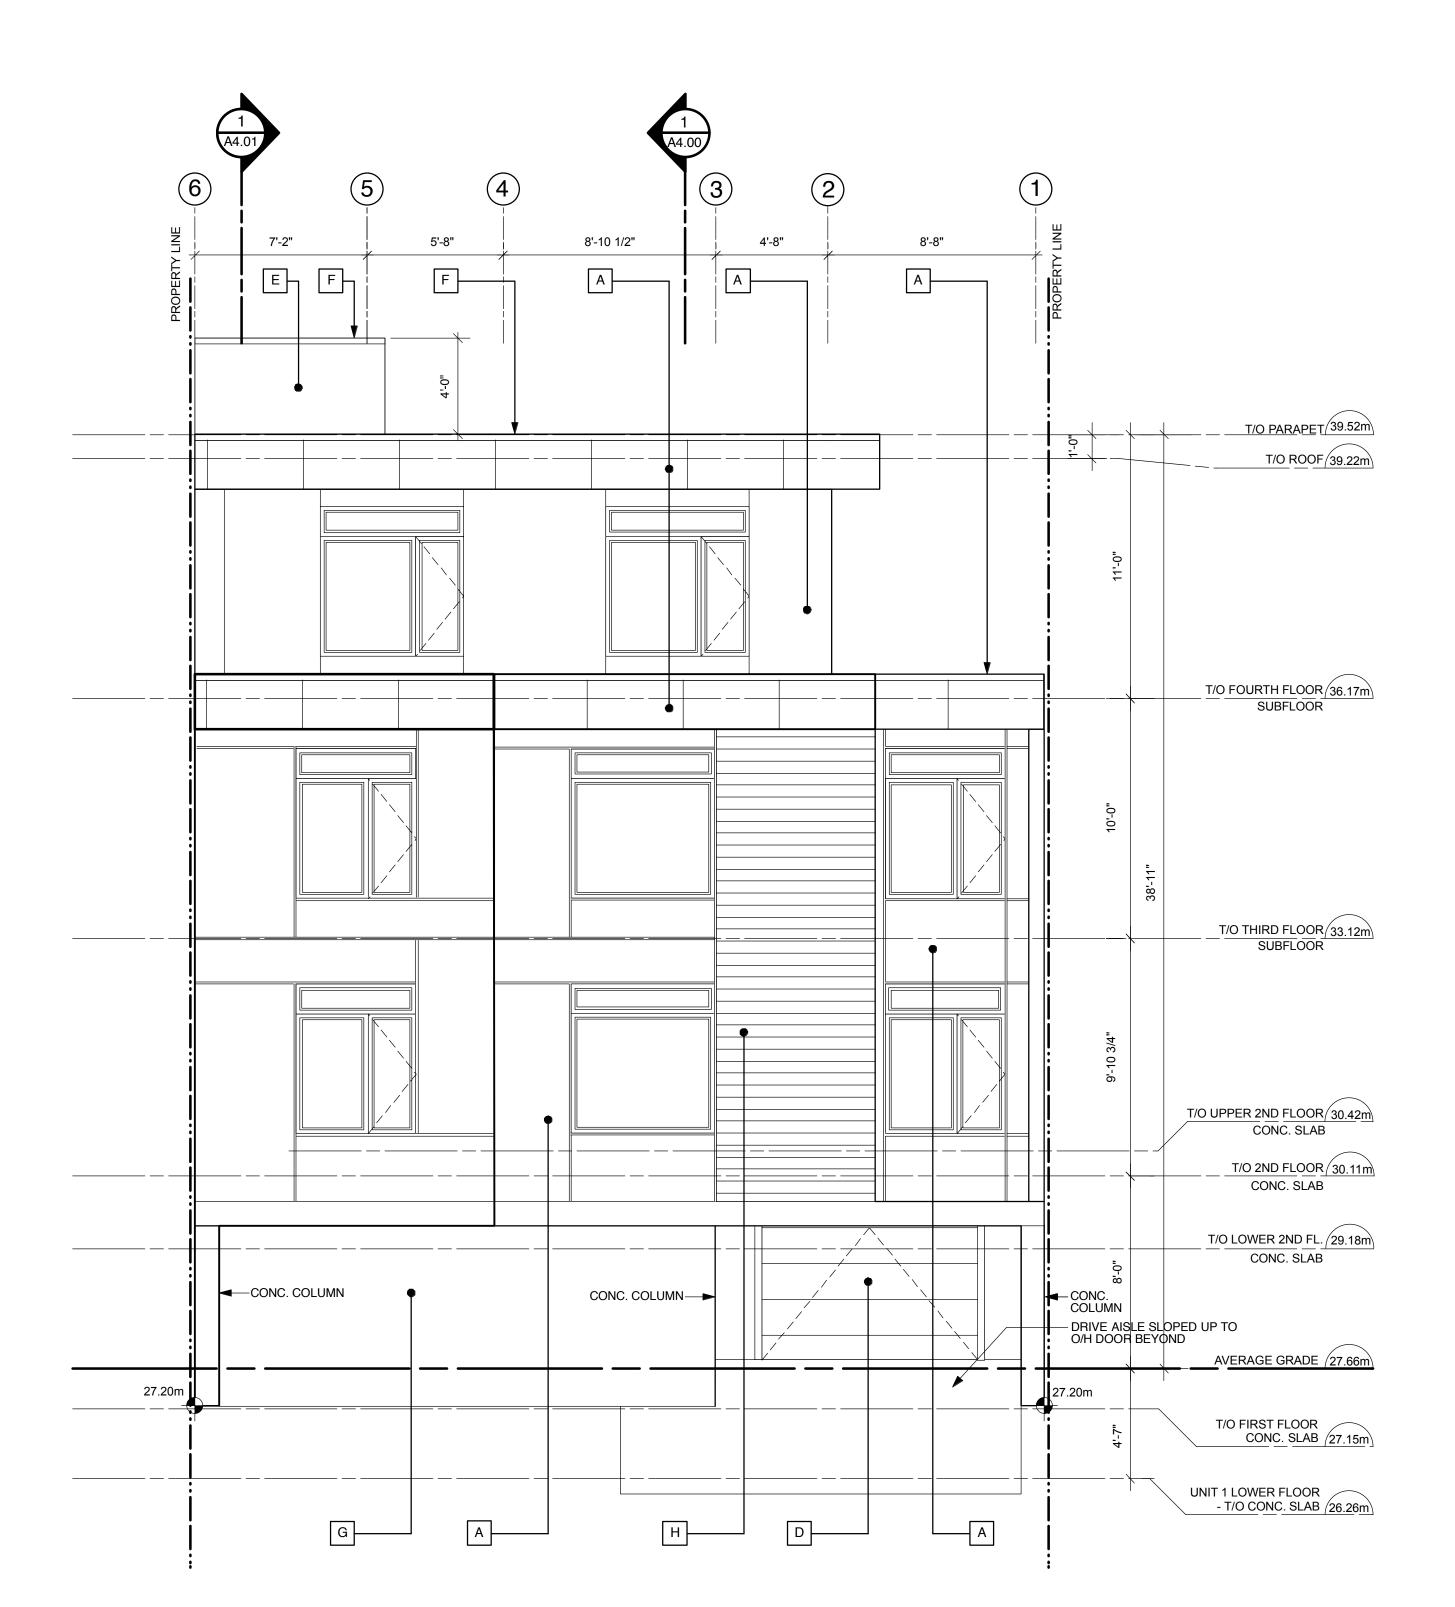


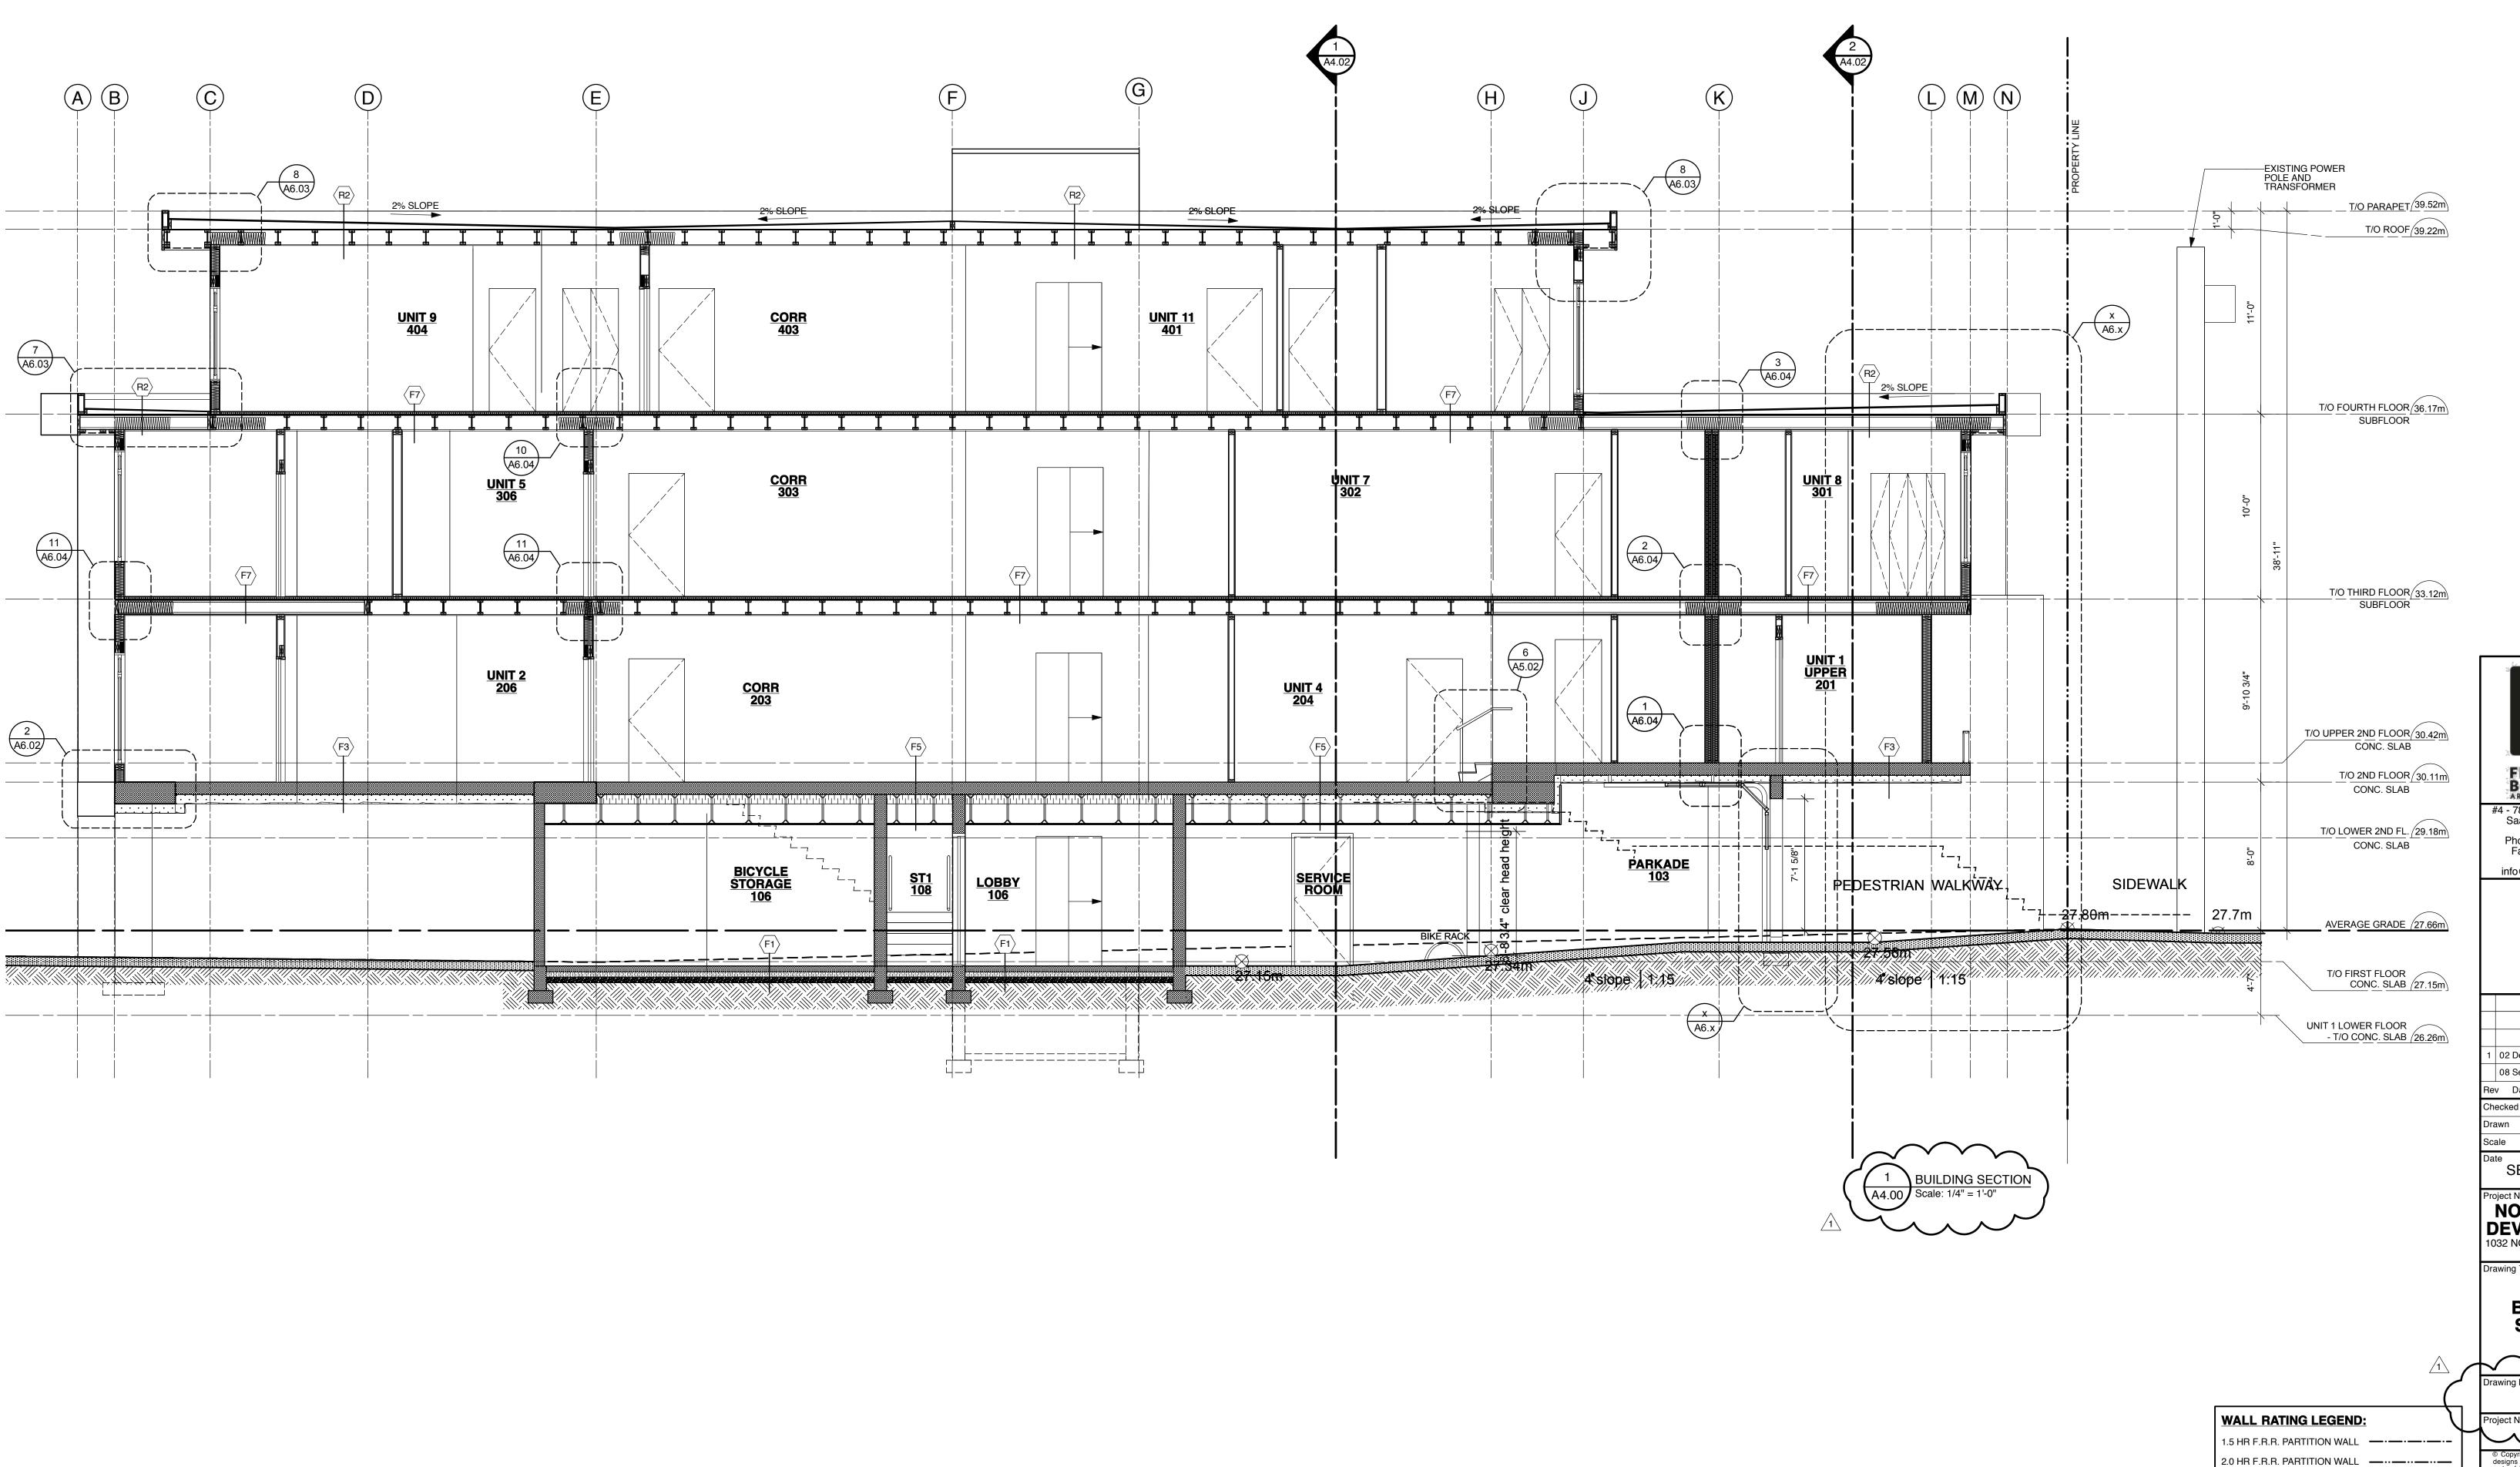




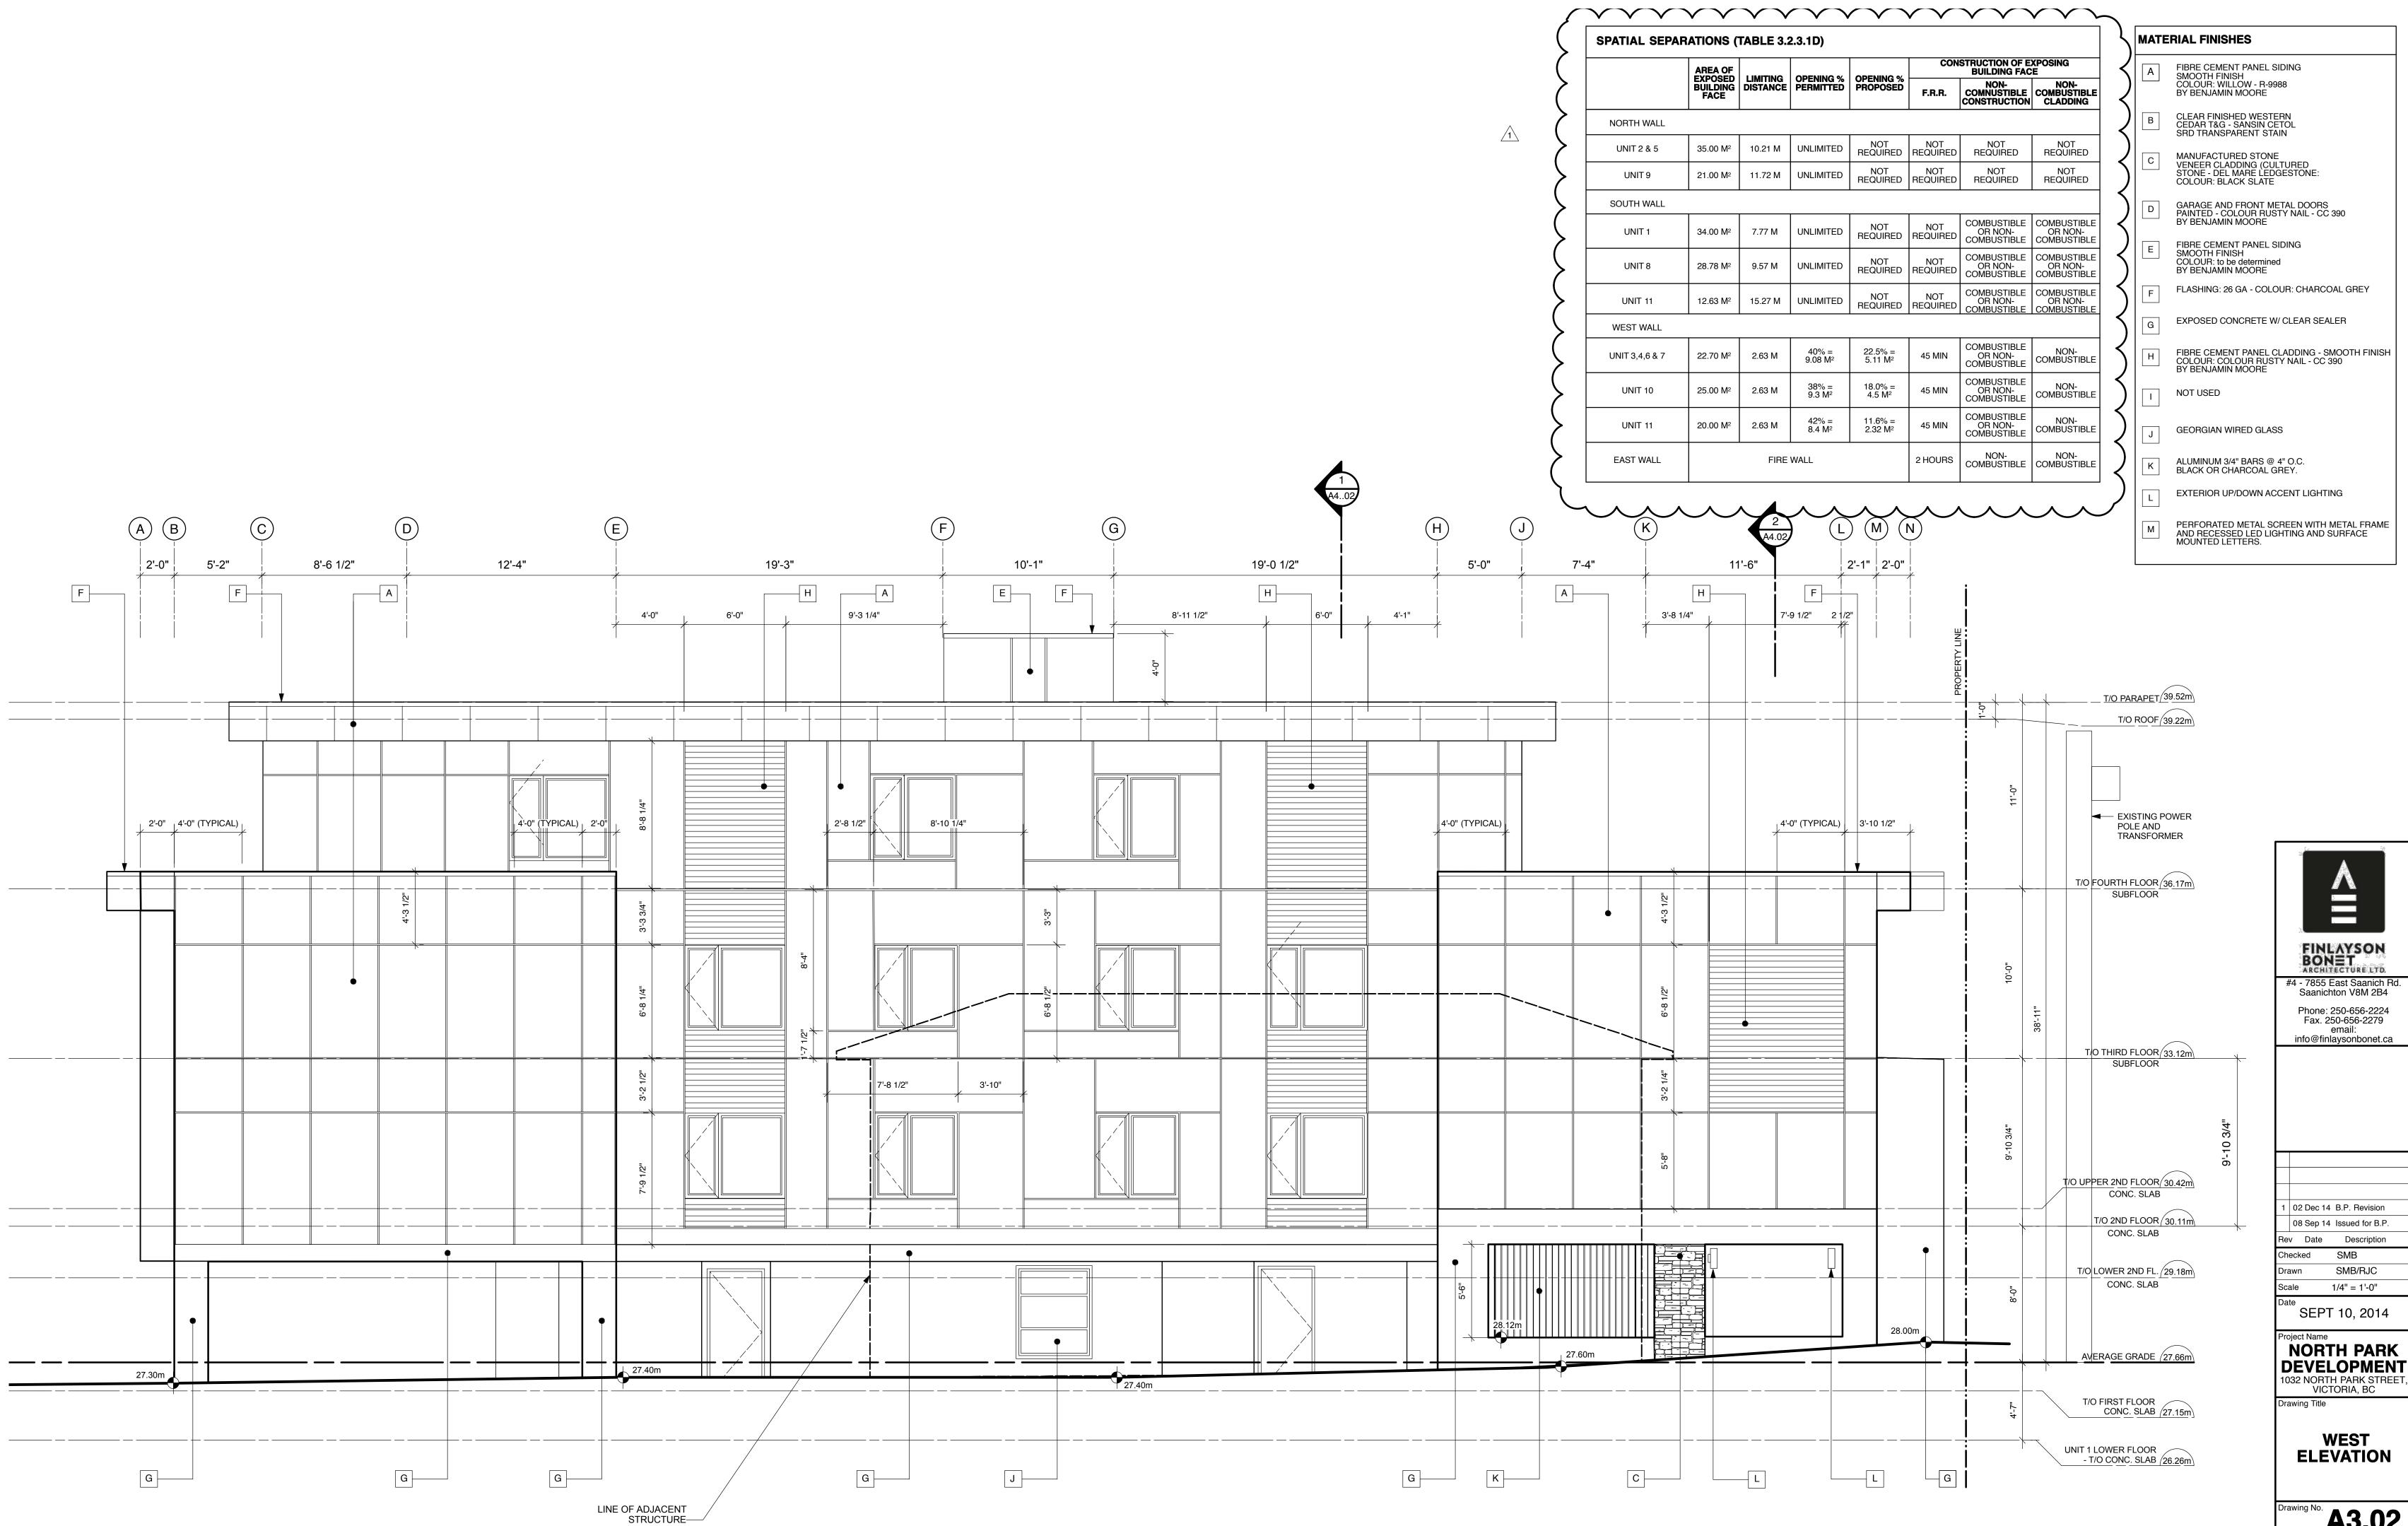
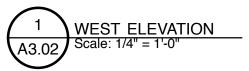
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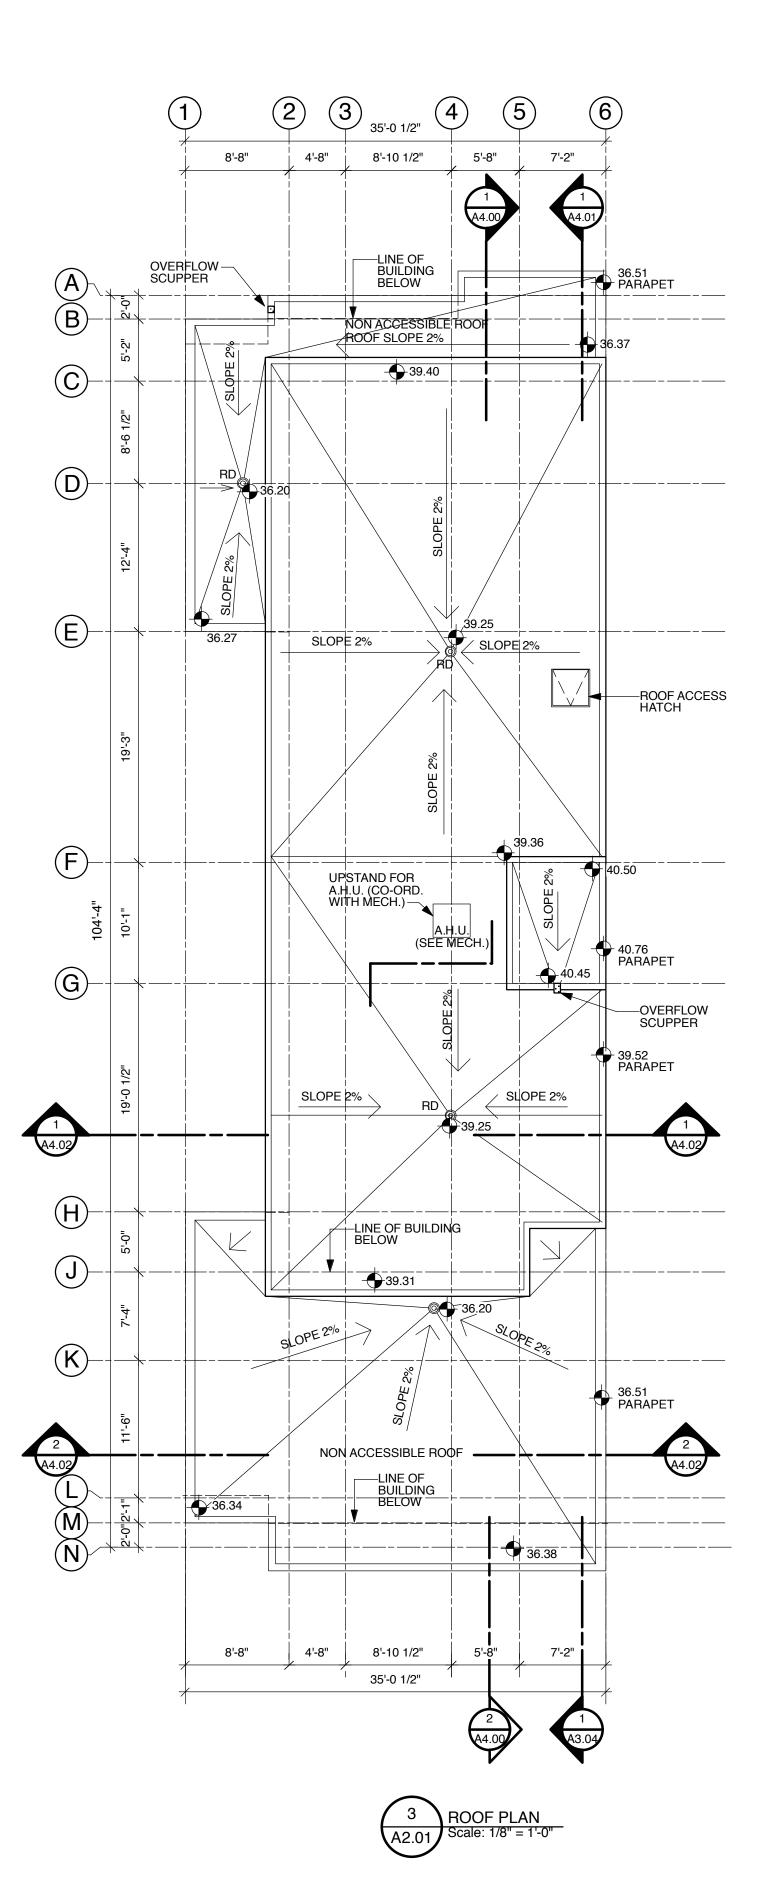



2 NORTH ELEVATION A3.00 Scale: 1/4" = 1'-0"

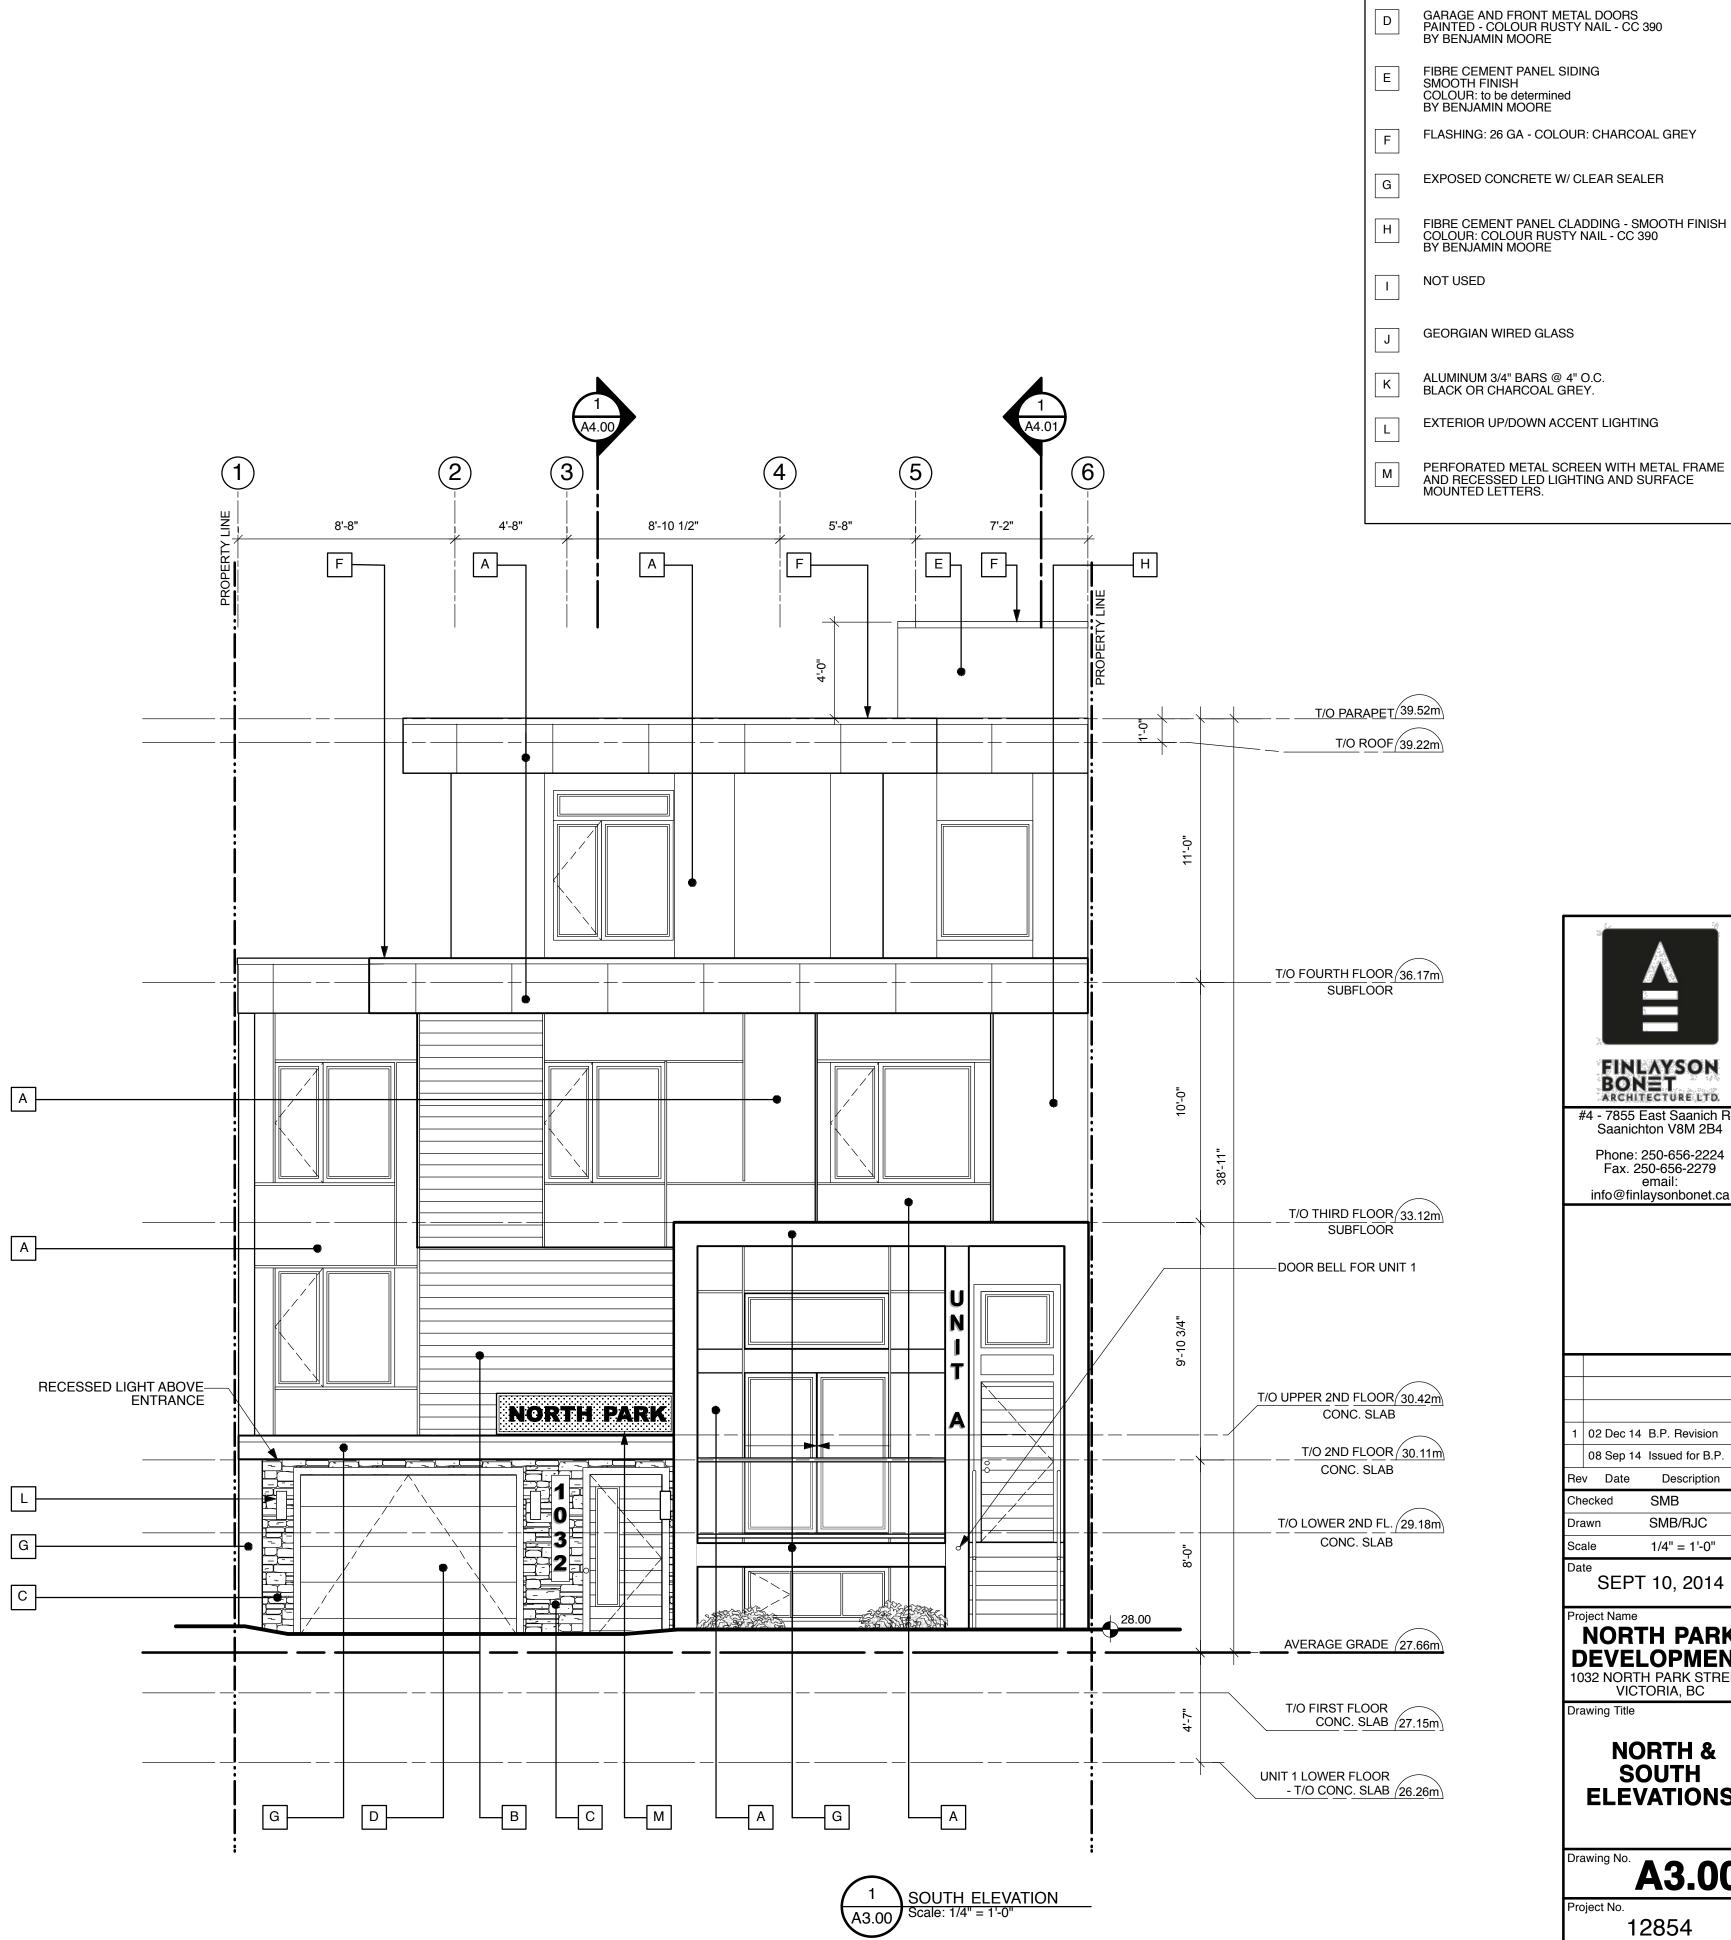



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Filone: 250-656-2224 Fax: 250-656-2279 email:
info@finlaysonbonet.ca
1 02 Dec 14 B.P. Revision
08 Sep 14 Issued for B.P. Rev Date Description
Checked SMB
Drawn SMB/RJC
Scale 1/4" = 1'-0"
Date SEPT 10, 2014
Project Name NORTH PARK DEVELOPMENT 1032 NORTH PARK STREET, VICTORIA, BC Drawing Title
NORTH & SOUTH ELEVATIONS
Drawing No. A3.00
Project No. 12854
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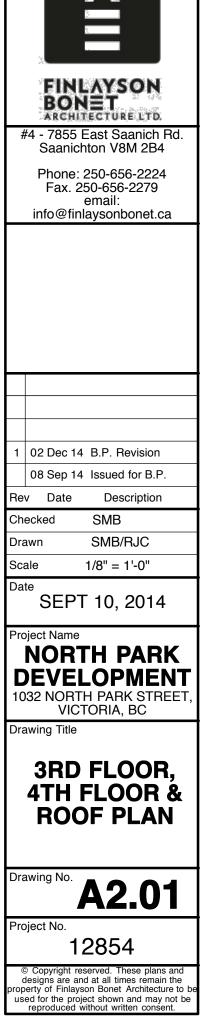
MATE	RIAL FINISHES
Α	FIBRE CEMENT PANEL SIDING SMOOTH FINISH COLOUR: WILLOW - R-9988 BY BENJAMIN MOORE
В	CLEAR FINISHED WESTERN CEDAR T&G - SANSIN CETOL SRD TRANSPARENT STAIN
С	MANUFACTURED STONE VENEER CLADDING (CULTURED STONE - DEL MARE LEDGESTONE: COLOUR: BLACK SLATE
D	GARAGE AND FRONT METAL DOORS PAINTED - COLOUR RUSTY NAIL - CC 390 BY BENJAMIN MOORE
E	FIBRE CEMENT PANEL SIDING SMOOTH FINISH COLOUR: to be determined BY BENJAMIN MOORE
F	FLASHING: 26 GA - COLOUR: CHARCOAL GREY
G	EXPOSED CONCRETE W/ CLEAR SEALER
Η	FIBRE CEMENT PANEL CLADDING - SMOOTH FINISH COLOUR: COLOUR RUSTY NAIL - CC 390 BY BENJAMIN MOORE
Ι	NOT USED
J	GEORGIAN WIRED GLASS
К	ALUMINUM 3/4" BARS @ 4" O.C. BLACK OR CHARCOAL GREY.
L	EXTERIOR UP/DOWN ACCENT LIGHTING







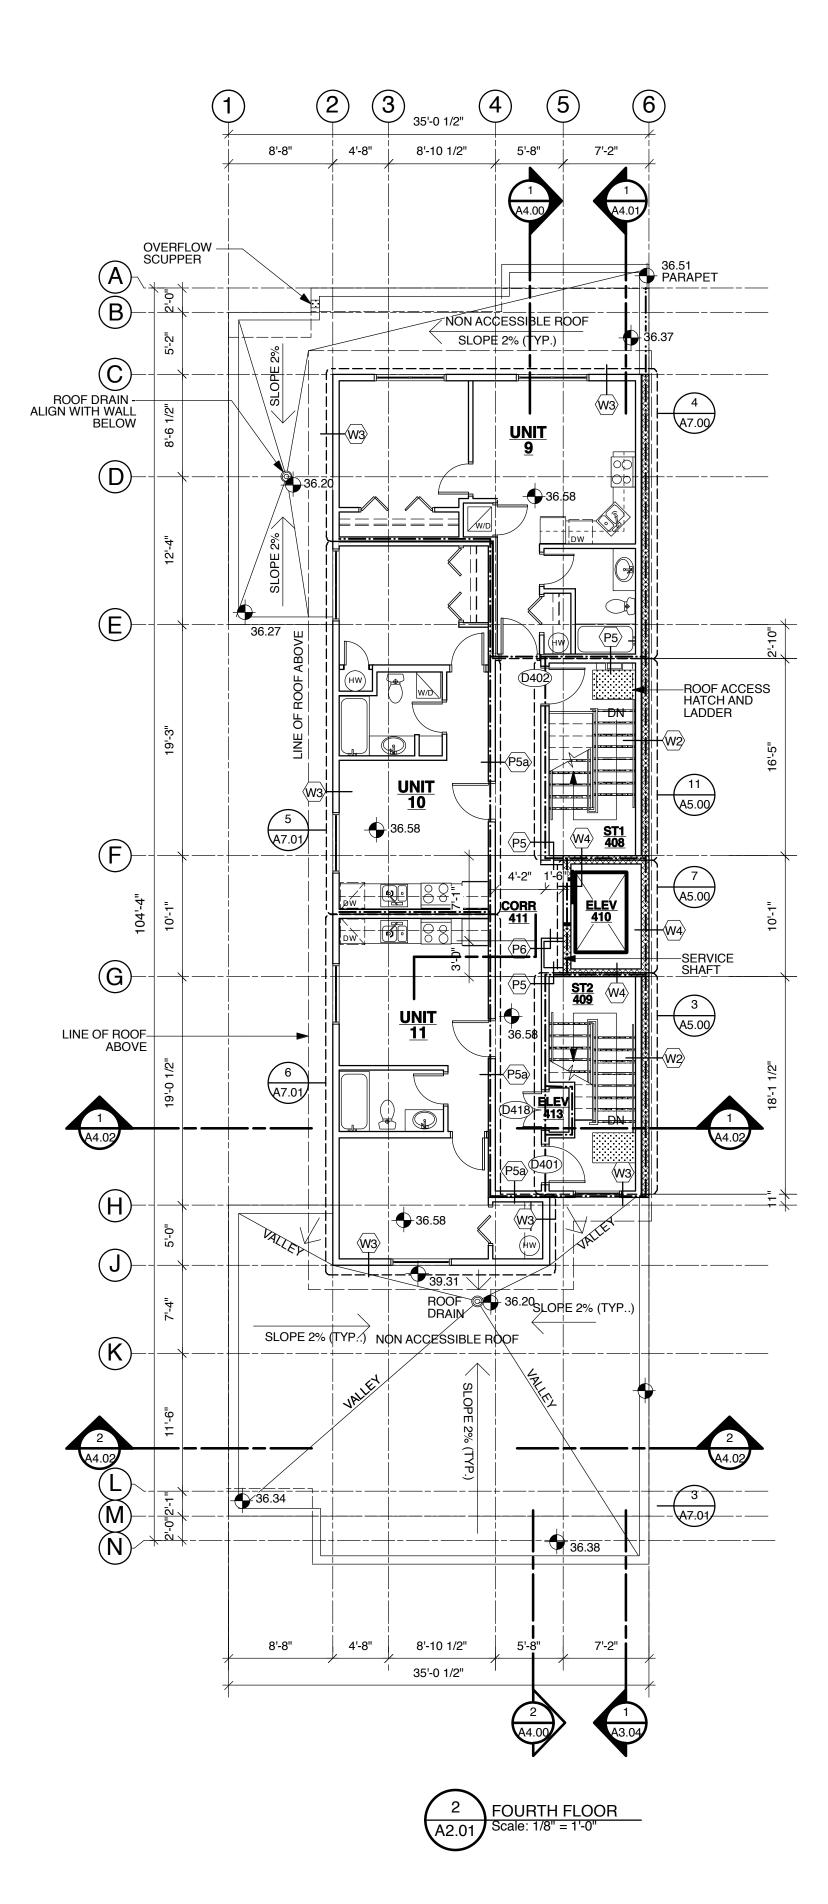


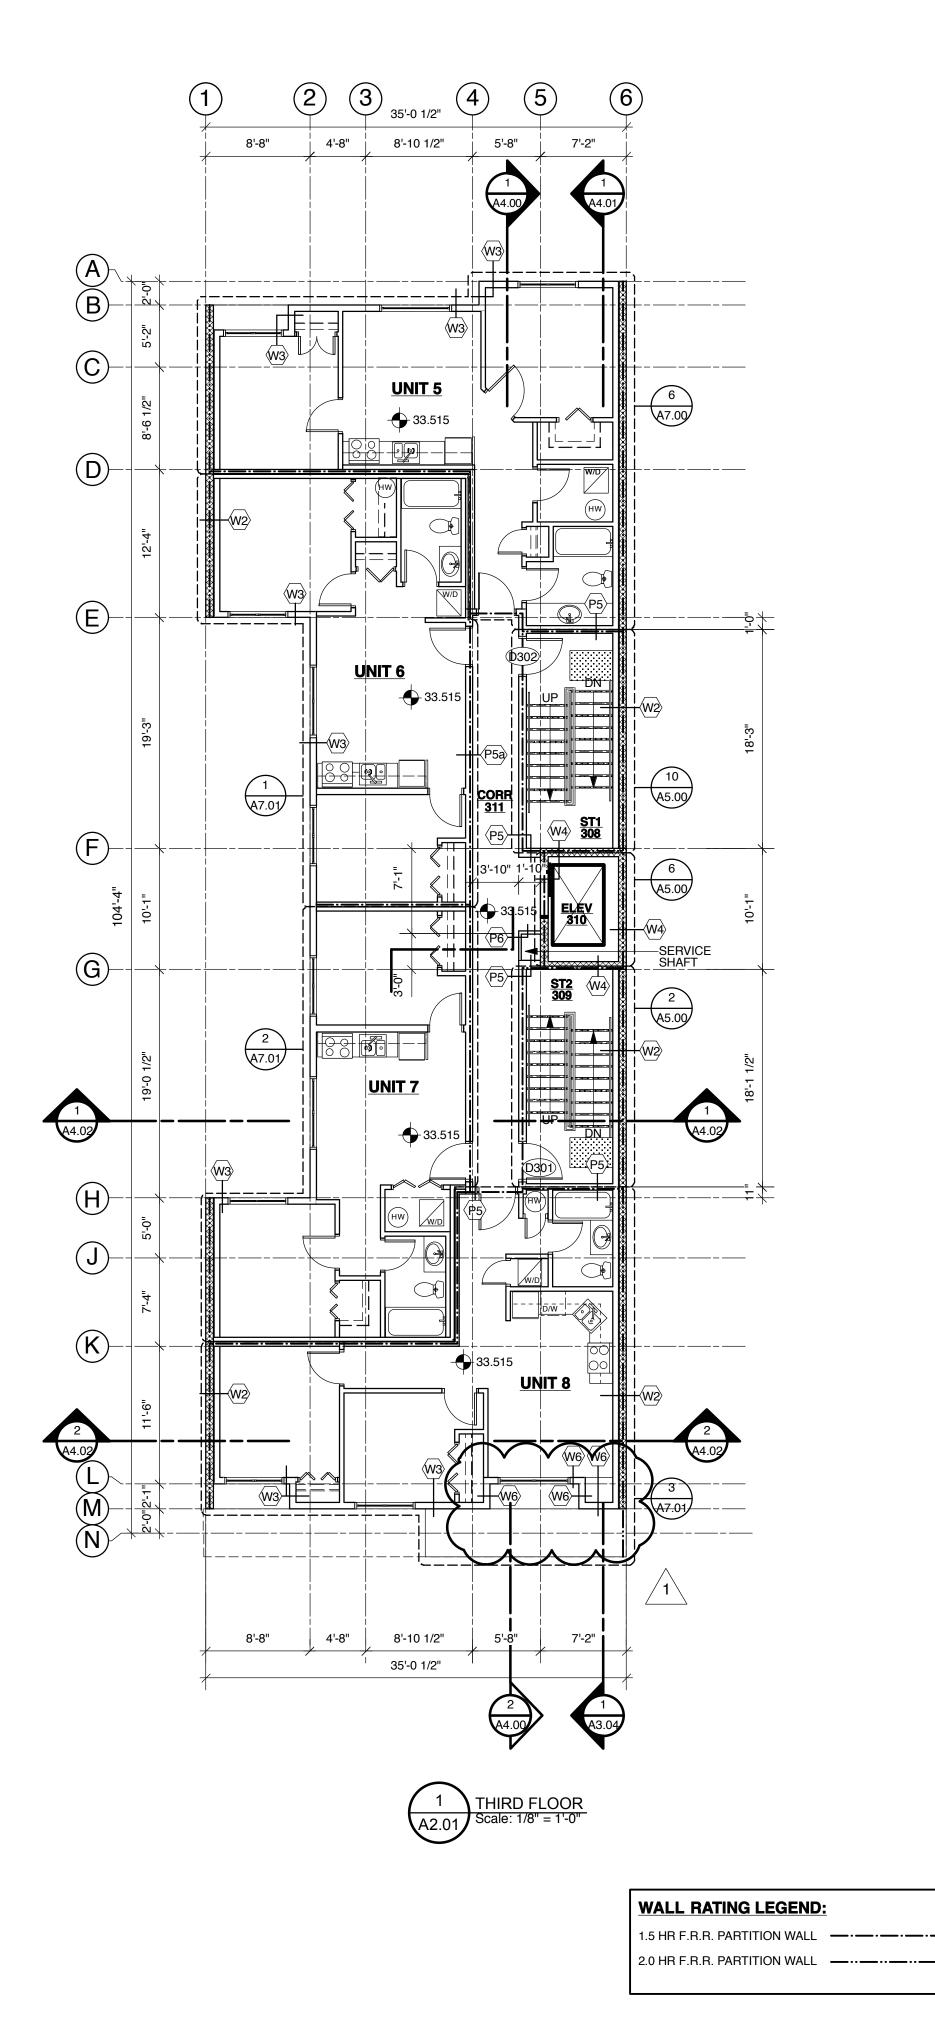

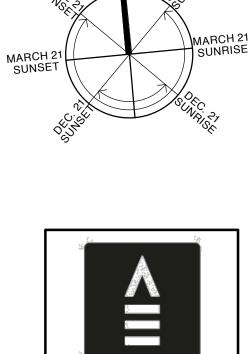


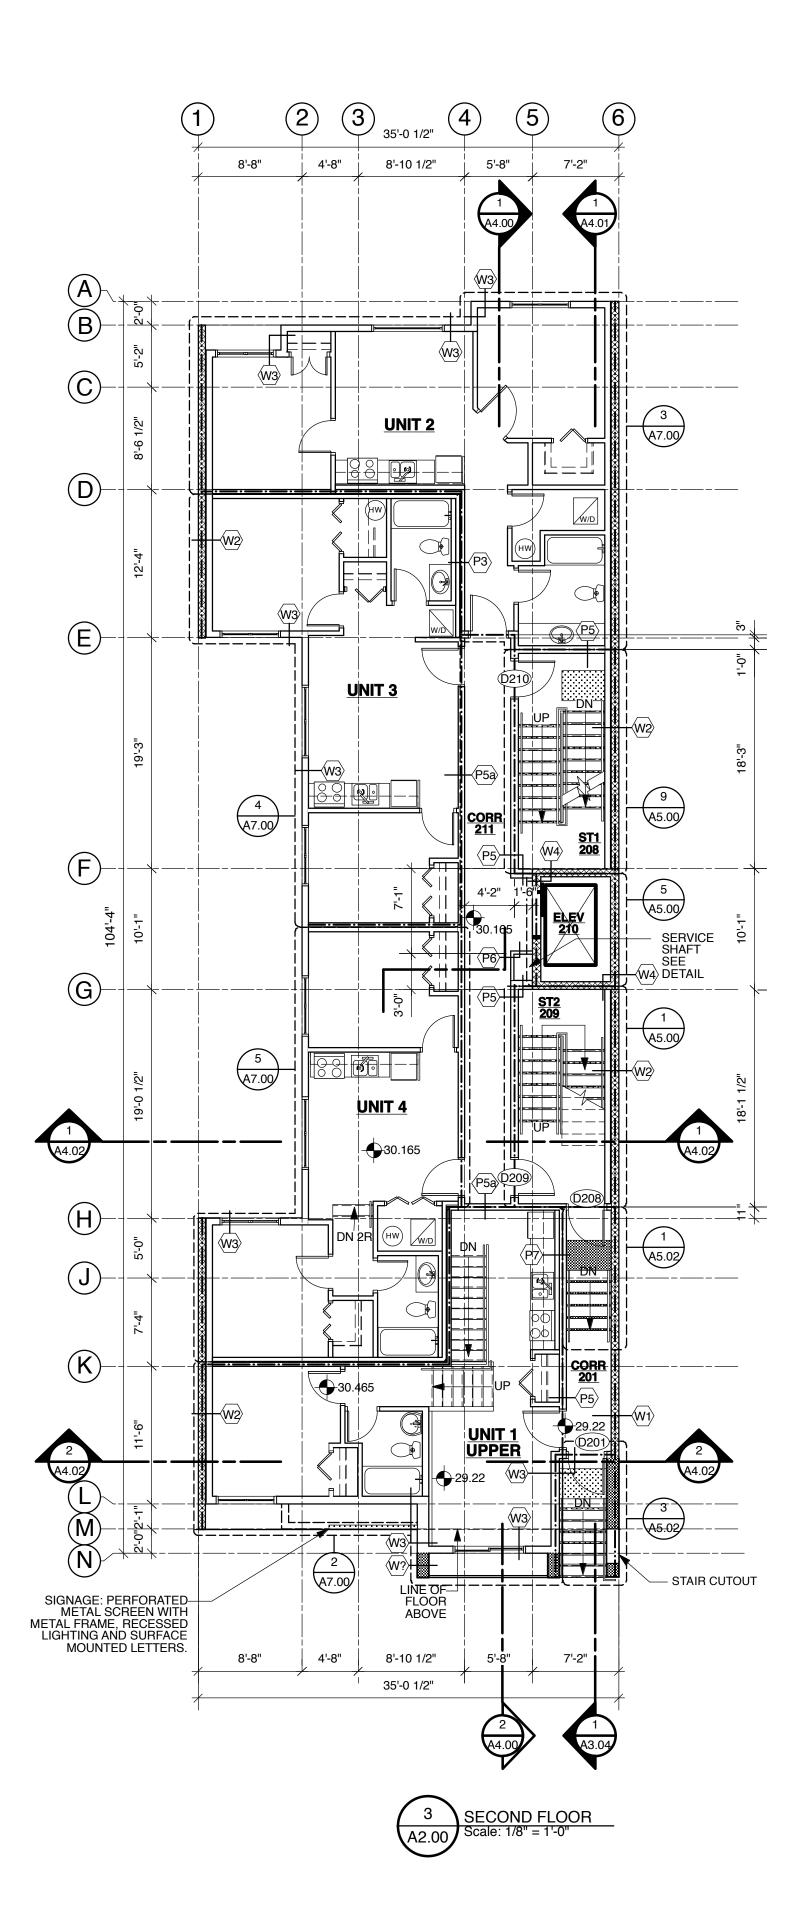


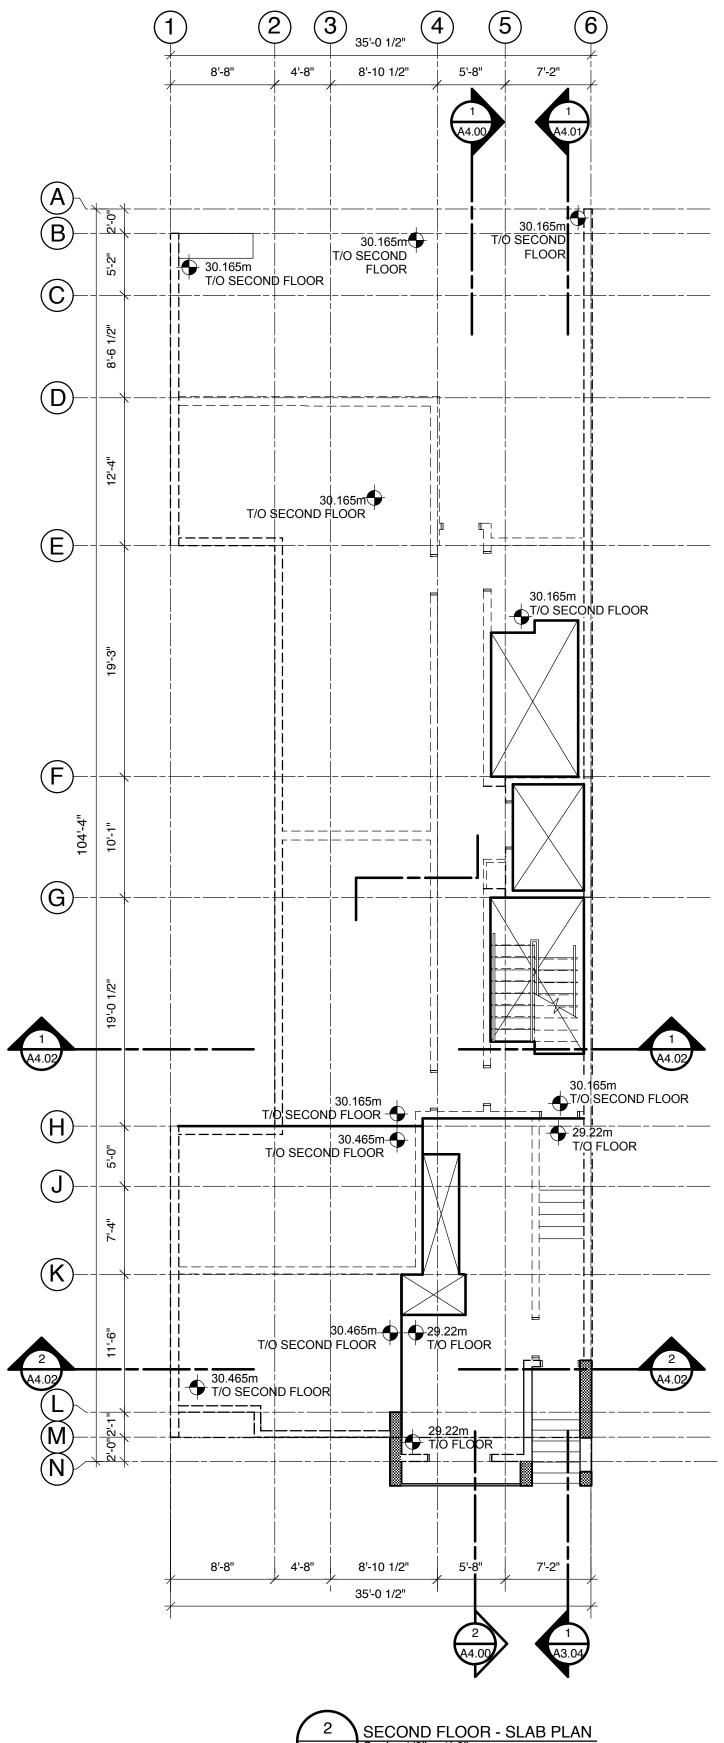

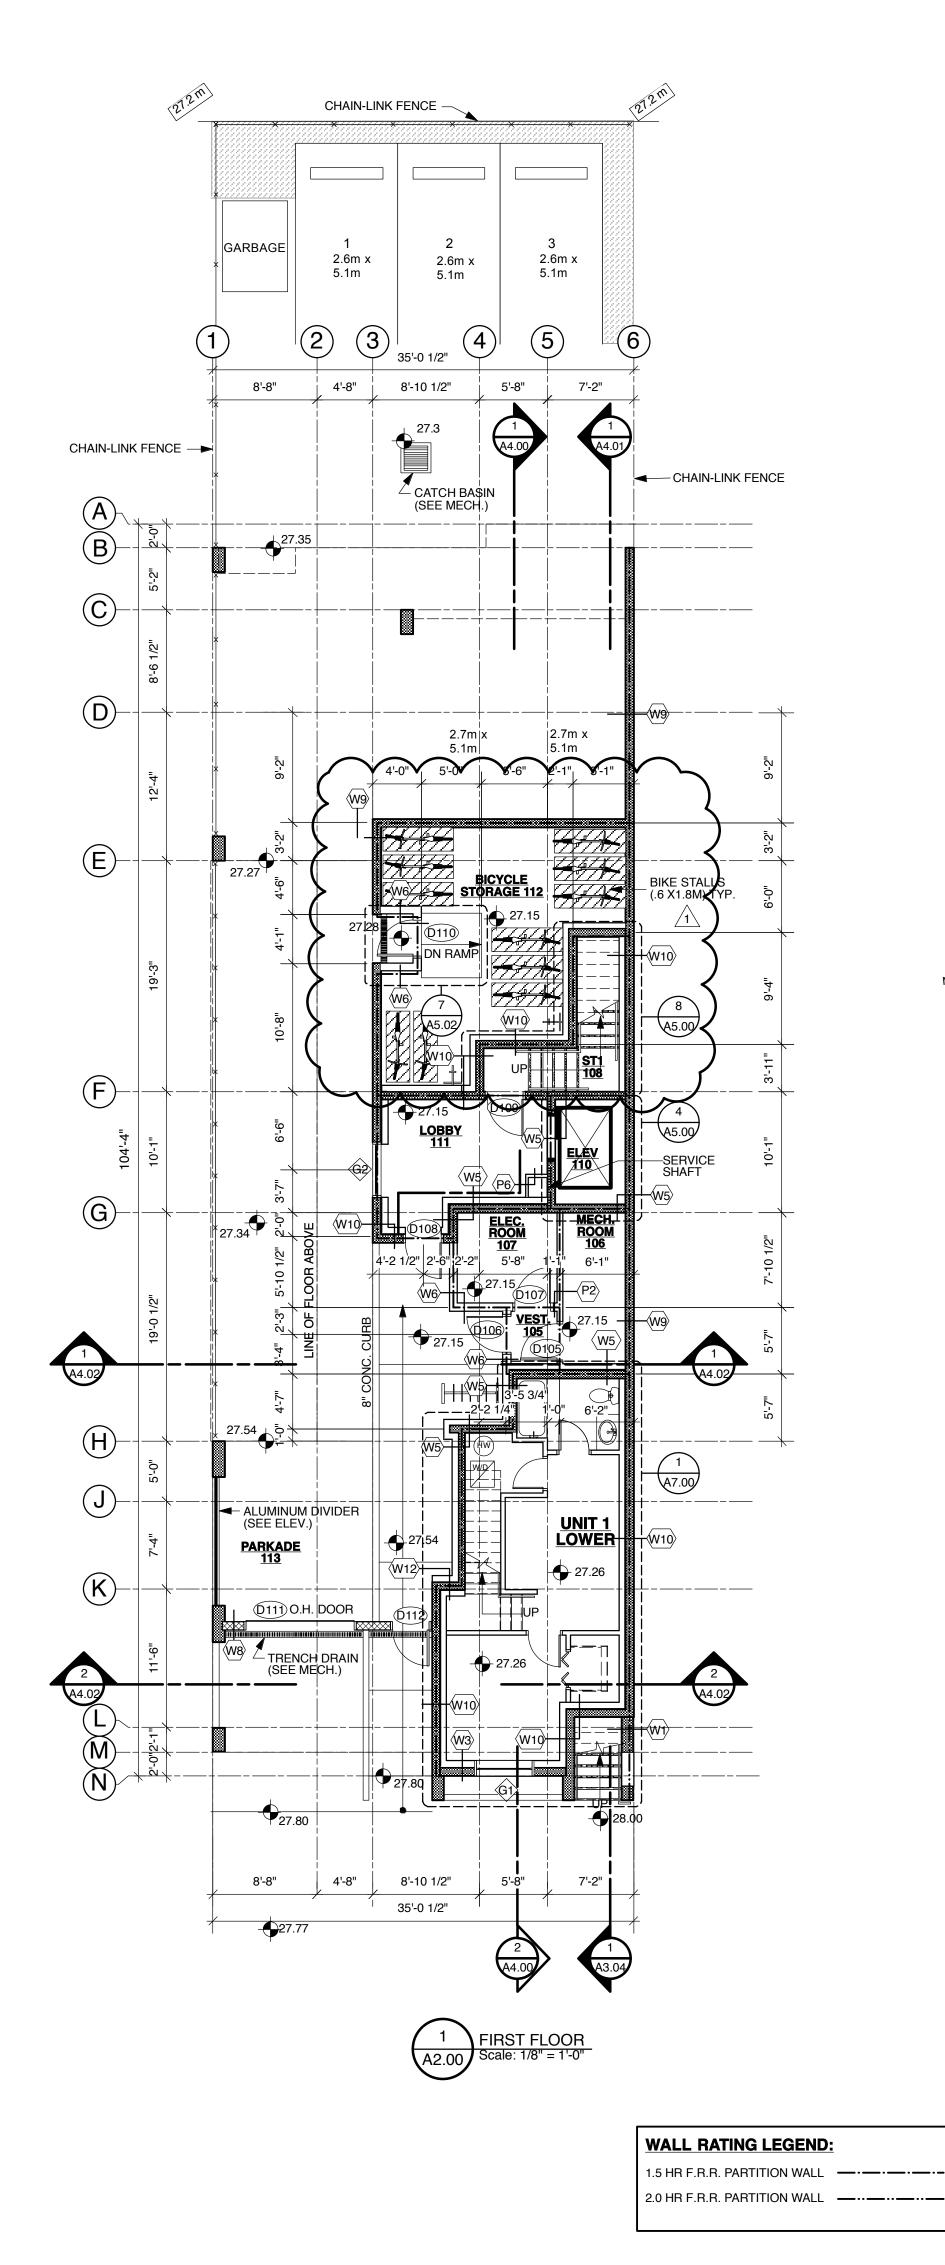


 $\frac{2}{A2.00}$ SECOND FLOOR - SLAB PLAN Scale: 1/8" = 1'-0" A2.00

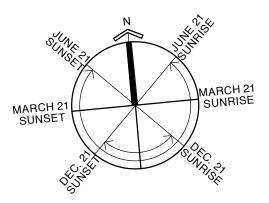


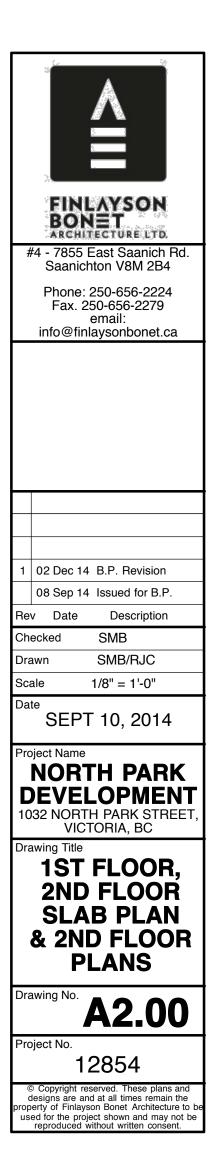


WAL	\sim	\sim		\sim		ION ASSEMBLIES	_		\sum		\sim	FLOOP	R ASSEMBLIES	-	\sim	\mathbf{r}		\sim
ASSEME NUMBE			U-VALUE (EFFECTIVE R-VALUE)	STC RATING	ASSEMBLY NUMBER	ILLUSTRATION (PLAN)	DESCRIPTION			U-VALVE (EFFECTIVE R-VALVE)	STC RATING	ASSEMBLY NUMBER	ILLUSTRATION (SECTION)			TESTING	U-VALUE (EFFECTIVE R-VALUE)	STC RATING
W1	TYPICAL EXTERIOR C.M.U. WALL • FIBRE CEMENT CLADDING SMOOTH FINISH • GALVANIZED HAT CHANNEL @ 24" O.C. • 2 LAYERS 30MIN. BUILDING PAPER OR 1 LAYER TYVEK COMMERCIAL WRAP • 8" CONCRETE MASONRY UNIT WITH WELDED WIRE MESH REINFORCEMENT IN MORTAR JOINTS		-	<u> </u>	P1	<u> </u>	TYPICAL INTERIOR 4 1/2" PARTITION • 1/2" GYPSUM WALLBOARD • 2 x 4 WOOD STUDS @ 16" O.C. • 1/2" GYPSUM WALLBOARD	45 min. F.F.R.) -		32	F1		FLOOR ASSEMBLY • 4" CONCRETE SLAB W/ ROOM FINISH (SLOPED TO DRAIN WHERE REQUIRED) • R12 EXTRUDED POLYSTYRENE RIGID INSULATION C/W SEAMS TAPEN W/ VAPOUR BARRIER TAPE • 4" COMPACTED GRANULAR FILL • ENGINEERED FILL / BEARING SOIL			-	<u> </u>
W2	TYPICAL EXTERIOR C.M.U. WALL • FIBRE CEMENT CLADDING SMOOTH FINISH • GALVANIZED HAT CHANNELS @ 24" O.C. • 2 LAYERS 30MIN. BUILDING PAPER OR 1 LAYER TYVEK COMMERCIAL WRAP • 8" CONCRETE MASONRY UNIT WITH WELDED WIRE MESH REINFORCEMENT IN MORTAR JOINTS • 1 LAYER 30 MINUTE BUILDING PAPER • 1/2" AIR SPACE	-	-	-	P2		TYPICAL INTERIOR 6 1/2" PARTITION • 1/2" GYPSUM WALLBOARD • 2 x 6 WOOD STUDS @ 16" O.C. • 1/2" GYPSUM WALLBOARD	-	-	-	32	F2		FLOOR ASSEMBLY • FLOOR FINISH / UNDERLAYMENT AS SPECIFIED • 8" REINFORCED CONCRETE SLAB • R12 (3") ROXUL COMFORTBOARD I/S MECHANICALLY FASTENED	2 HR. F.R.R.	-	-	-
	• 2 x 6 WOOD STUDS @ 16" O.C. • R12 MINERAL WOOL BATT INSULATION • 6 MIL VAPOUR POLY BARRIER • 1/2" GYPSUM WALLBOARD TYPICAL EXTERIOR 6 1/2" WALL				P3		PARTY WALL • 5/8" TYPE 'X' GYPSUM WALLBOARD • R12 ACOUSTIC BATT INSULATION • 2 x 4 WOOD STUDS @ 16" O.C. • 1" AIR SPACE • 2 x 4 WOOD STUDS @ 16" O.C. • R12 ACOUSTIC BATT INSULATION • 5/8" TYPE 'X' GYPSUM WALLBOARD	1 HR. F.R.R.	-	-	57	F3		FLOOR ASSEMBLY • FLOOR FINISH / UNDERLAYMENT AS SPECIFIED • 8" REINFORCED CONCRETE SLAB • R12 (3") POLYURETHANE FOAM INSULATION	2 HR. F.R.R.	-	-	-
W 3	 FIBRE CEMENT CLADDING SMOOTH FINISH 1 x3 PRESSURE TREATED STRAPPING @ 16" O.C. 2 LAYERS 30MIN. BUILDING PAPER OR 1 LAYER TYVEK COMMERCIAL WRAP 1/2" PLYWOOD SHEATHING 2 x6 WOOD STUDS @ 16" O.C. R24 MINERAL WOOL BATT INSULATION 6 MIL POLY VAPOUR BARRIER 5/8" TYPE 'X' GYPSUM WALLBOARD 	-	-	-	P4	<pre>WWWXWWWWWWWWWWWWWWWWWWWWWWWWWWWWWWWWW</pre>	PARTY WALL • 5/8" TYPE 'X' GYPSUM WALLBOARD • R12 ACOUSTIC BATT INSULATION • 2 x 4 WOOD STUDS @ 16" O.C. • 1" AIR SPACE • 2 x 4 WOOD STUDS @ 16" O.C. • R12 ACOUSTIC BATT INSULATION • 5/8" TYPE 'X' GYPSUM WALLBOARD	-	-	-	-	F4		FLOOR ASSEMBLY • FLOOR FINISH / UNDERLAYMENT AS SPECIFIED • 8" REINFORCED CONCRETE SLAB • 2-1/4" FURRING CHANNELS • 5/8" TYPE 'C' GYPSUM WALLBOARD		-	-	-
W4	TYPICAL ELEVATOR SHAFT WALL • 8" CONCRETE MASONRY UNIT WITH WELDED WIRE MESH 1 HR. • 8" CONCRETE MASONRY UNIT WITH WELDED WIRE MESH F.R.R. FEINFORCEMENT IN MORTAR JOINTS F.R.R.		-	50	P5		TYPICAL INTERIOR 6 1/2" PARTITION • 2 LAYERS 5/8" GYPSUM WALLBOARD • 2x6 WOOD STUDS @ 16" O.C. • R20 BATT INSULATION • 2 LAYERS 5/8" GYPSUM WALLBOARD	1 HR. F.R.R.	-	-	38	-		FLOOR ASSEMBLY • FLOOR FINISH / UNDERLAYMENT AS SPECIFIED • 8" REINFORCED CONCRETE SLAB	1 HR. F.R.R.			
W5	REINFORCED CONCRETE WALL • FIBRE CEMENT CLADDING SMOOTH FINISH • 1 x 3 PRESSURE TREATED STRAPPING @ 16" O.C. • 2 LAYERS 30MIN. BUILDING PAPER OR 1 LAYER TYVEK COMMERCIAL WRAP • 1/2" PLYWOOD SHEATHING • 2 x 6 WOOD STUDS @ 16" O.C. • 200mm REINFORCEMENT CONCRETE WALL (REFER TO STRUCTURAL)				P5a		TYPICAL INTERIOR 6 1/2" PARTITION • 2 LAYERS 5/8" GYPSUM WALLBOARD • 2x6 TOP AND BOTTOM PLATES • 2x4 STAGGERED WOOD STUDS @ 16" O.C. • R20 BATT INSULATION • 2 LAYERS EVEN WALLBOARD	1 HR. F.R.R.		· ·	56	F5		SUSPENDED CEILING R28 FIBREGLASS BATT INSULATION 1 LAYER 5/8" TYPE 'X' GYPSUM WALLBOARD	F.R.R.	-	-	-
w6	TYPICAL EXTERIOR 6 1/2" WALL (NON-COMBUSTIBLE) • FIBRE CEMENT CLADDING SMOOTH FINISH • 1 x3 VERTICAL HAT CHANNELS @ 16" O.C. • 2 LAYERS 30MIN. BUILDING PAPER OR 1 LAYER TYVEK COMMERCIAL WRAP • 1/2" DENSGLASS SHEATHING OR GLASS FACED EXTRIOR GYPSUM BOARD • R24 MINERAL WOOL BATT INSULATION	- ·	-	$+$ ϵ	-)		• 2 LAYERS 5/8" GYPSUM WALLBOARD • 5/8" GYPSUM WALLBOARD • 5/8" GYPSUM WALLBOARD • 2x2 STEEL STUDS @ 16" O.C. • 5/8" GYPSUM WALLBOARD	45 MIN. F.R.R.			35	F6		FLOOR ASSEMBLY • FLOOR FINISH / UNDERLAYMENT AS SPECIFIED • 1 1/2" GYPSUM CONCRETE TOPPING • 5/8" PLYWOOD SHEATHING • 2 x 10 @16" O.C. C/W CROSS BRIDGING • RESILIENT CHANNELS @ 16" O.C. • 1 LAYER 5/8" TYPE 'X' GYPSUM WALLBOARD	-	-	-	-
	• 6 MIL POLY VAPOUR BARRIER • 5/8" TYPE 'X' GYPSUM WALLBOARD • FIBRE CEMENT CLADDING SMOOTH FINISH • 1 x 3 PRESSURE TREATED STRAPPING @ 16" O.C. • 2 LAYERS SOMIN. BUILDING PAPER OR 1 LAYER TYVEK COMMERCIAL WRAP				Р7		TYPICAL INTERIOR 6 1/2" PARTITION • 5/8" GYPSUM WALLBOARD • 2x6 WOOD STUDS @ 16" O.C. • R12 BATT INSULATION • 5/8" GYPSUM WALLBOARD • 2x4 WOOD STUDS @ 16" O.C. • 5/8" GYPSUM WALLBOARD	1 HR. F.R.R.	-	-	-	F7		TJI FLOOR ASSEMBLY • FLOOR FINISH / UNDERLAYMENT AS SPECIFIED • 1 1/2" GYPSUM CONCRETE TOPPING • 5/8" T&G SHEATHING • 9-7/8" TJI @ 16" O.C. W/ CROSS BRACING • R12 MINERAL FIBRE BATT INSULATION • RESILIENT CHANNELS @ 16" O.C. • 2 LAYERS 5/8" TYPE 'X' GYPSUM WALLBOARD	1 HR. F.R.R.	-	-	59
W7	1/2" PLYWOOD SHEATHING 2 x6 WOOD STUDS @ 16" O.C. 1/2" PLYWOOD SHEATHING 2 LAYERS 30MIN. BUILDING PAPER OR 1 LAYER TYVEK COMMERCIAL WRAP 1 x 3 PRESSURE TREATED STRAPPING @ 16" O.C. FIBRE CEMENT CLADDING SMOOTH FINISH	-	-	-	P8		ELEVATOR CONTROL CLOSET PARTITION • 2 LAYERS - 5/8" GYPSUM WALLBOARD • 2x4 WOOD STUDS @ 16" O.C. • R12 BATT INSULATION • 2 LAYERS - 5/8" GYPSUM WALLBOARD	1.5 HR. F.R.R.	-	-	38	 F8		FLOOR ASSEMBLY • FLOOR FINISH / UNDERLAYMENT AS SPECIFIED • 5/8" PLYWOOD SHEATHING • 2 x 10 @16" O.C. C/W CROSS BRIDGING • 2 LAYER 5/8" TYPE 'X' GYPSUM WALLBOARD			-	
W8	EXTERIOR CMU WALL WITH STONE VENEER • 8" CONCRETE MASONRY UNIT WITH WELDED WIRE MESH REINFORCEMENT IN MORTAR JOINTS • TYPE 'N' OR 'S' MORTAR	-	-									ROOF	ASSEMBLIES					
	MANUFACTURED STONE VENEER CLADDING				_							ASSEMBLY NUMBER	ILLUSTRATION (SECTION)	DESCRIPTION	FIRE RATING	TESTING AGENCY	U-VALUE (EFFECTIVE R-VALUE)	STC RATING
W9	REINFORCED CONCRETE WALL • FIBRE CEMENT CLADDING SMOOTH FINISH • GALVANIZED HAT CHANNEL @ 24" O.C. • 2 LAYERS 30MIN. BUILDING PAPER OR 1 LAYER TYVEK COMMERCIAL WRAP • 200mm REINFORCEMENT CONCRETE WALL (REFER TO STRUCTURAL)		-	-								R1		ROOF ASSEMBLY • 2 PLY SBS MODIFIED BITUMEN MEMBRANE • PROTECTION BOARD • 5/8" PLYWOOD SHEATHING • 2 x 10 @16" O.C. C/W CROSS BRIDGING • R28 FIBREGLASS BATT INSULATION • RESILIENT CHANNELS • 6 MIL POLY VAPOUR BARRIER • 1 LAYER 5/8" TYPE 'X' GYPSUM WALLBOARD	-	-	-	-
W10	REINFORCED CONCRETE WALL • FIBRE CEMENT CLADDING SMOOTH FINISH • GALVANIZED HAT CHANNEL @ 24" O.C. • 2 LAYERS 30MIN. BUILDING PAPER OR 1 LAYER TYVEK COMMERCIAL WRAP • 200mm REINFORCEMENT CONCRETE WALL (REFER TO STRUCTURAL) • 1 LAYER 30 MINUTE BUILDING PAPER • 1/2" AIR SPACE • 2 x 6 WOOD STUDS @ 16" O.C. • R12 MINERAL WOOL BATT INSULATION • 6 MIL VAPOUR POLY BARRIER • 1/2" GYPSUM WALLBOARD	-	-	-								R2		ROOF ASSEMBLY • 2 PLY SBS MODIFIED BITUMEN MEMBRANE • PROTECTION BOARD • 5/8" PLYWOOD SHEATHING • 9-7/8" TJI @ 16" O.C. WI CROSS BRACING • R28 FIBREGLASS BATT INSULATION • RESILIENT CHANNELS • 6 MIL POLY VAPOUR BARRIER • 1 LAYER 5/8" TYPE 'X' GYPSUM WALLBOARD		-	-	-
W11	REINFORCED CONCRETE WALL 2 HR. • 200mm REINFORCEMENT CONCRETE WALL (REFER TO STRUCTURAL) 2 HR.	-	-	-	_													
W12	REINFORCED CONCRETE WALL • FIBRE CEMENT CLADDING SMOOTH FINISH • 1 x 3 PRESSURE TREATED STRAPPING @ 16" O.C. • 2 LAYERS 30MIN. BUILDING PAPER OR 1 LAYER TYVEK COMMERCIAL WRAP • 1/2" PLYWOOD SHEATHING • 2 x 6 WOOD STUDS @ 16" O.C. • 200mm REINFORCEMENT CONCRETE WALL (REFER TO STRUCTURAL) • 1 LAYER 30 MINUTE BUILDING PAPER • 2 x 4 WOOD STUDS @ 16" O.C. • R12 MINERAL WOOL BATT INSULATION • 6 MIL VAPOUR POLY BARRIER • 1/2" GYPSUM WALLBOARD	-	-	-														
w13	PARAPET • FIBRE CEMENT CLADDING SMOOTH FINISH • 1 x 3 PRESSURE TREATED STRAPPING @ 16" O.C. • 2 LAYERS 30MIN. BUILDING PAPER OR 1 LAYER TYVEK COMMERCIAL WRAP • 1/2" PLYWOOD SHEATHING • 2 x 6 WOOD STUDS @ 16" O.C. • 1/2" PLYWOOD SHEATHING • PROTECTION BOARD • 2 PLY SBS MODIFIED BITUMEN MEMBRANE	-	-	-														
W14	TYPICAL EXTERIOR C.M.U. WALL • FIBRE CEMENT CLADDING SMOOTH FINISH • GALVANIZED HAT CHANNELS @ 24" O.C. • 2 LAYERS 30MIN. BUILDING PAPER OR 1 LAYER TYVEK COMMERCIAL WRAP • 8" CONCRETE MASONRY UNIT WITH WELDED WIRE MESH REINFORCEMENT IN MORTAR JOINTS • 2 LAYERS 30MIN. BUILDING PAPER OR 1 LAYER TYVEK COMMERCIAL WRAP	-	-	-														

SEMBLY JMBER	ILLUSTRATION (SECTIO
R1	
R2	

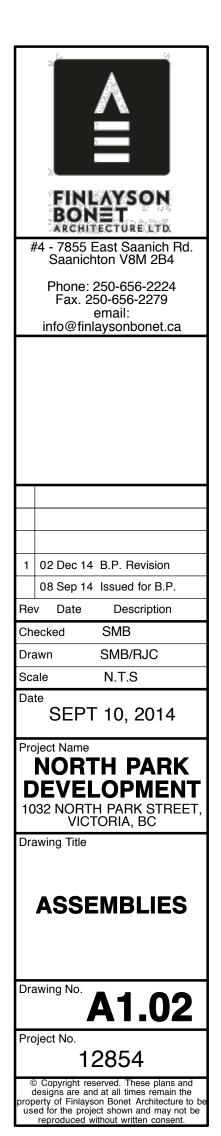


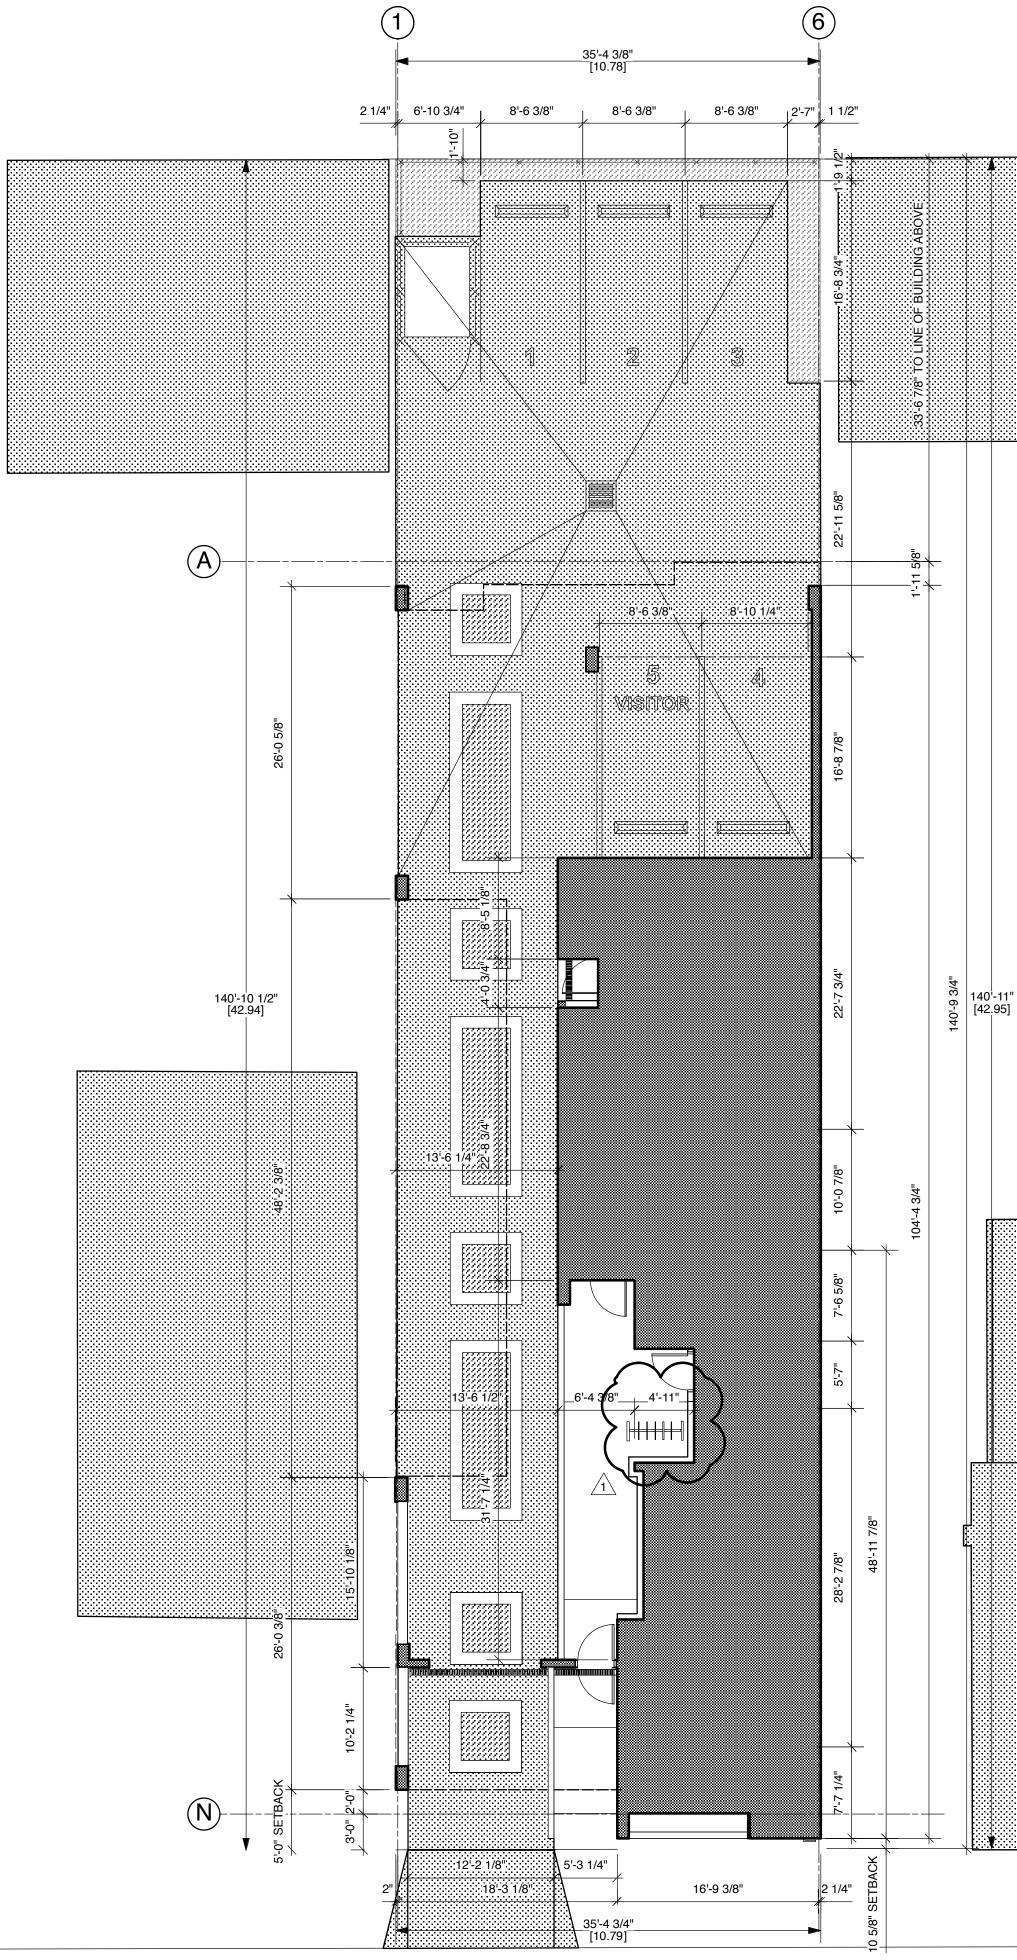





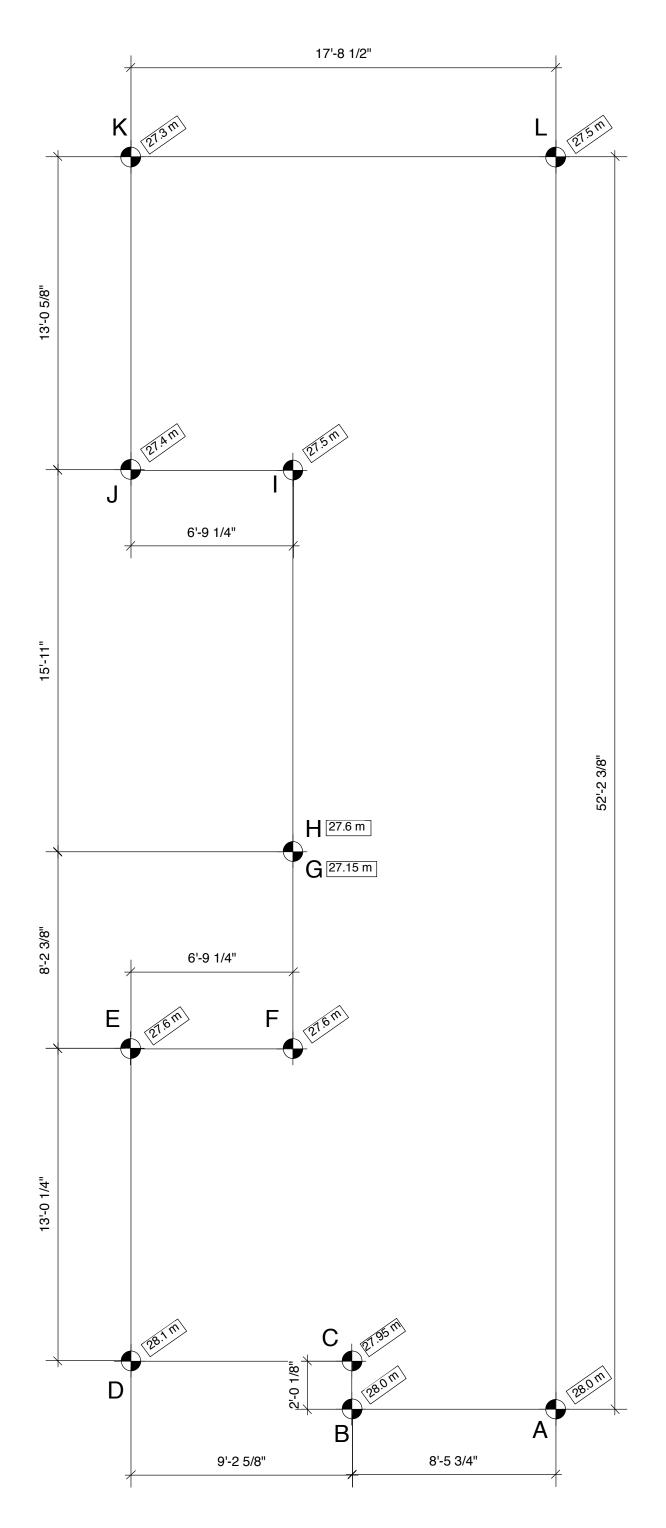

GRADE POINTS	AVERAGE OF POINTS		E BETWEEN E POINTS	TOTALS
OINTS A & B	((28.0 + 28.0) /2)	Х	5.17	= 144.760
POINTS B & C	((28.0 + 27.95) /2)	Х	1.23	= 34.409
POINTS C & D	((27.95 + 28.1) /2)	Х	5.62	= 157.500
POINTS D & E	((28.1 + 27.6) /2)	Х	7.94	= 221.129
POINTS E & F	((27.6 + 27.6) /2)	Х	4.13	= 113.988
POINTS F & G	((27.6 + 27.15) /2)	Х	5.00	= 136.875
POINTS H & I	((27.6 + 27.5) /2)	Х	9.70	= 267.235
POINTS I & J	((27.5 + 27.4) /2)	Х	4.13	= 113.368
POINTS J & K	((27.4 + 27.3) /2)	Х	7.95	= 217.432
POINTS K & L	((27.3 + 27.5) /2)	Х	10.79	= 295.646
POINTS L & A	((27.5 + 28.0) /2)	Х	31.82	= 883.005
			TC	DTAL = 2585.347

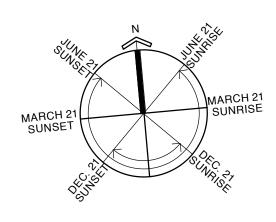

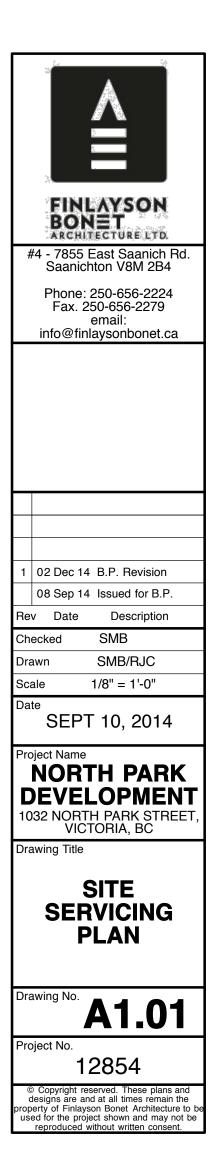

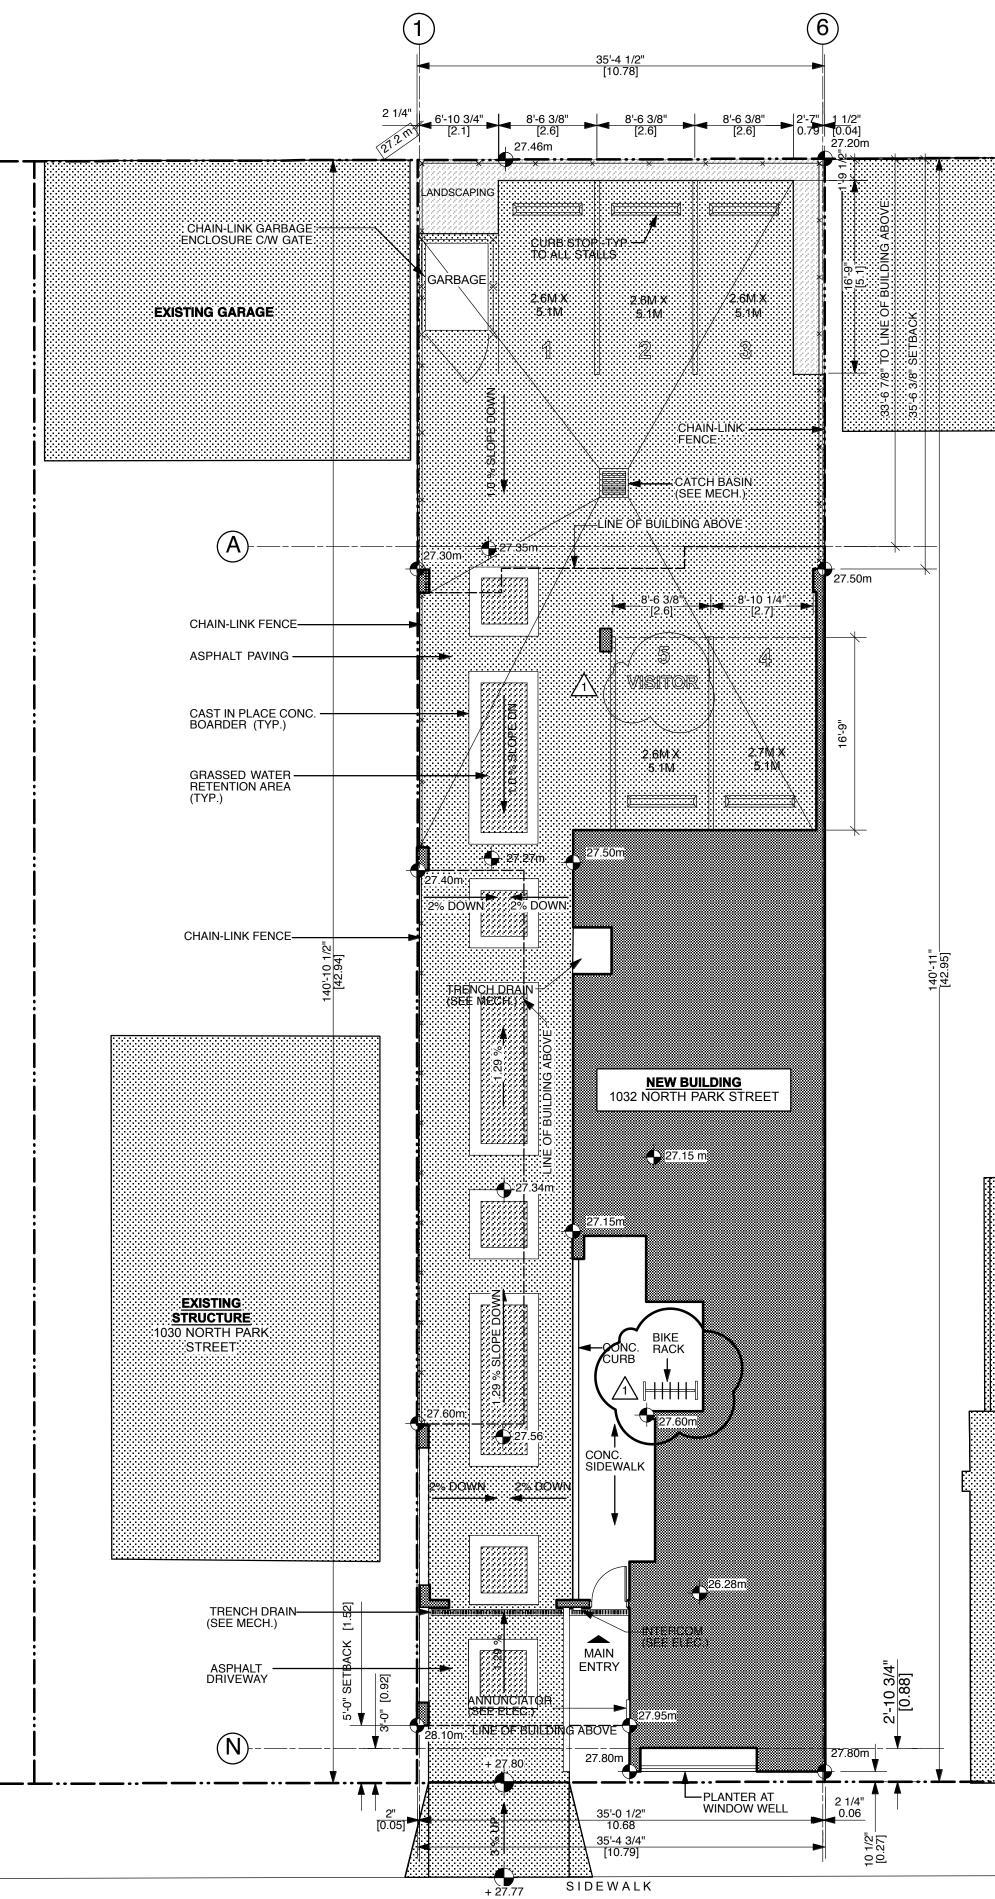

EXISTING GARAGE EXISTING CARPORT EXISTING STRUCTURE 15.42 1 SITE PLAN A1.00 Scale: 1 : 100 $\sqrt{1}$

EASTERLY 35 FEET OF LOT 22, LOT 23, AND THE WESTERLY 24 FEET OF LOT 24, SUBURBAN LOT 13, VICTORIA CITY, PLAN 26 LEGAL DESCRIPTION: CURRENT ZONING: CR-NP - NORTH PARK COMMERCIAL RESIDENTIAL DISTRICT LOT AREA: 458 M² AREA OF 1st FLOOR: 106.91 M² (COMMON AREA AND LOWER FLOOR OF UNIT 1 BELOW 1.8M FROM AVERAGE GRADE TO CEILING) AREA OF 2nd FLOOR: 254.3 M² AREA OF 3nd FLOOR: 260.3 M² AREA OF 4th FLOOR: 156.9 M² FSR: 458 x1.5 = 687 M² PROPOSED FSR= 1.47 : 1 (671.5 M² ÷ 458 M²) LOT COVERAGE: 298.47 M² - 65% 4 STOREYS - 12M AVERAGE GRADE: 27.662 M TOTAL NUMBER OF UNITS: 11 7 - 2 BEDROOMS 3 - 1 BEDROOMS 1 TOWNHOUSE UNIT AREAS: 79.3 M² (40.7 M² + 38.6 M²) 54.8 M² 49.2 M² 48.0 M² 54.8 M² 49.2 M² 48.0 M² 54.4 M² 39.9 M² 34.7 M² 34.2 M² **5 PARKING STALLS** PROPOSED PARKING: BICYCLE STORAGE: 17 SECURED BICYCLE STALLS 6 VISITOR BICYCLE PARKING SETBACKS: FRONT: 0.27 M² REAR: 10.24 M² SIDE: 0 M² OPEN SITE SPACE: 2.7% BUILDING: PARKING: TOTAL: 137.21 M² +308.41 M² 445.62 M² LOT AREA: BUILDING & PARKING: 458.00 M² -445.62 M² 12.38 M² OPEN SITE SPACE: $\begin{array}{r} 12.38 \text{ M}^2\\ \underline{\div 458.00 \text{ M}}^2\\ 0.027\end{array}$ OPEN SITE SPACE: LOT AREA:

PROJECT DATA:

HEIGHT:

UNIT 1:

UNIT 2

UNIT 3

UNIT 4

UNIT 5

UNIT 6

UNIT 7

UNIT 8

UNIT 9

UNIT 10

UNIT 11

AVERAGE GRADE: 27.30 + 27.50 + 27.40 + 27.50 + 27.60 + 27.95 + 28.10 + 28.00 + 27.60 = 276.95 / 10 = 27.69 M

FINLAYSON BONET ARCHITECTURE LTD #4 - 7855 East Saanich Rd. Saanichton V8M 2B4 Phone: 250-656-2224 Fax. 250-656-2279 email: info@finlaysonbonet.ca 02 Dec 14 B.P. Revision 08 Sep 14 Issued for B.P. Rev Date Description necked SMB/RJC rawn 1 :100 Scale SEPT 10, 20 piect Name **NORTH PARK** DEVELOPMENT 1032 NORTH PARK STREET, VICTORIA, BC Drawing Title SITE PLAN & PROJECT DATA awing No **A1.00** roject No 12854 © Copyright reserved. These plans and designs are and at all times remain the property of Finlayson Bonet Architecture to be used for the project shown and may not be reproduced without written consent.

MARCH 2 SUNSE